



NOTES:

- 1.) FOR GENERAL NOTES & LEGEND SEE PSI DVG. #V049-3-001 SHT. 1.
- 2.) FOR LIST OF CIVIL CONTRACTOR REFERENCE DWGS. WITH CURRENT REVISIONS SEE PSI DVG. #V049-3-001 SHT. 2.
- 3.) CONDUIT IS SHOWN DIAGRAMMATICALLY AND SHALL BE FIELD VERIFIED SO AS TO OPTIMIZE SUPPORTING MEANS AND TO AVOID INTERFERENCES WITH PIPING SYSTEMS.
- 4.) IDENTIFY ALL CONNECTION BOXES WITH BLACK PHENOLIC TAGS WITH WHITE LETTERING. LETTERING SHALL BE 3/8" HIGH.
- 5.) ALL CONDUIT SHALL BE EMT UNLESS OTHERWISE NOTED.

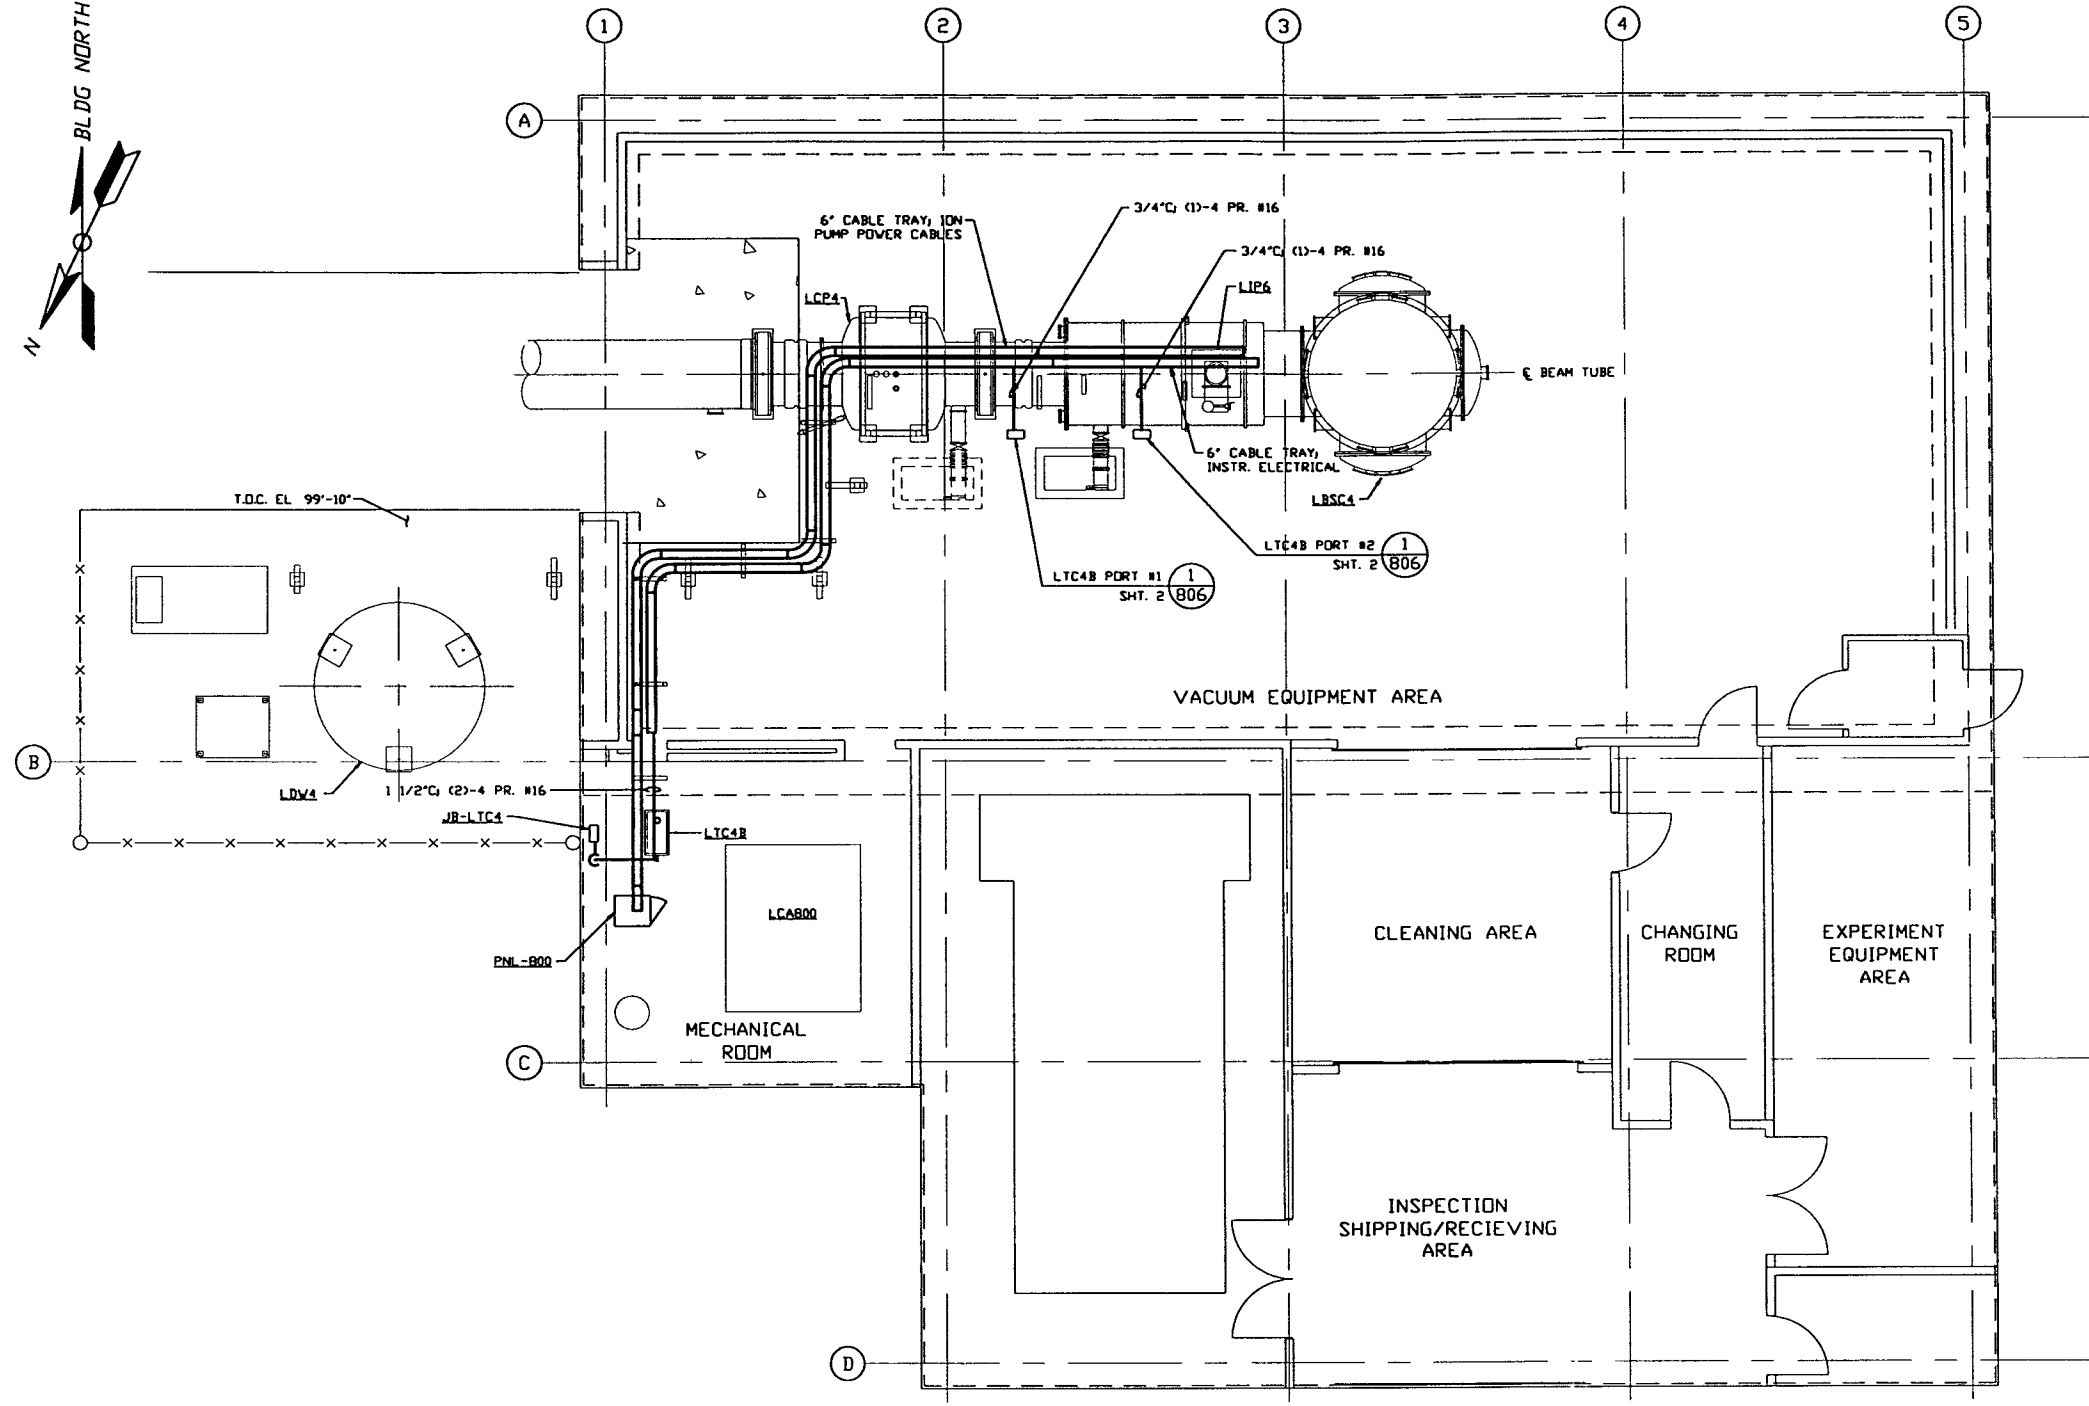


RIGHT END STATION PLAN @ EL. 100'-0"

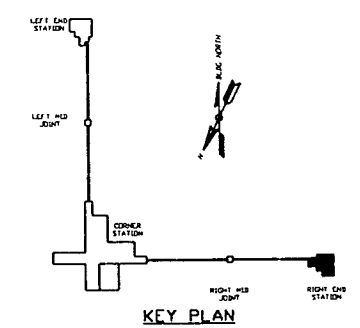

PRELIMINARY NOT FOR CONSTRUCTION

LIGO-D970150-00-V

| | | | | | | | | | | | |
|--|--|--|--|--|--|--|--|---|--|--|--|
| <p>PROPRIETARY AND CONFIDENTIAL</p> <p>THIS DOCUMENT CONTAINS PROPRIETARY INFORMATION BELONGING TO PROCESS SYSTEMS INTERNATIONAL, INC. OR ITS SUBSIDIARIES AND SHALL BE KEPT CONFIDENTIAL AND NOT BE DISCLOSED OR REPRODUCED FOR ANY PURPOSE FOR WHICH IT WAS SUPPLIED. IT SHALL NOT BE COPIED, REPRODUCED OR OTHERWISE USED, NOR SHALL SUCH INFORMATION BE FURNISHED IN WHOLE OR IN PART TO OTHERS EXCEPT IN ACCORDANCE WITH THE TERMS OF ANY AGREEMENT UNDER WHICH IT WAS SUPPLIED OR WITH THE PRIOR WRITTEN CONSENT OF PROCESS SYSTEMS INTERNATIONAL, INC. AND SHALL BE RETURNED UPON REQUEST.</p> | | | | <p>UNLESS OTHERWISE SPECIFIED DIMENSIONS ARE IN INCHES</p> <p>TOLERANCES: FRACTIONAL & ANGULAR: 1/16" - 3/32" BEND: 1/2" TWO PLACE DECIMAL & 3/16" THREE PLACE DECIMAL & .005 FINISHED SURFACE: THIS SIDE OUT REMOVE ALL BURRS</p> | | | | <p>PROCESS SYSTEMS INTERNATIONAL, INC. 20 WALKUP DR. WESTBOROUGH, MASSACHUSETTS 01581 USA</p> | | | |
| <p>V049-3-008 EQUIP. ARRANGEMENT LOUISIANA RIGHT END STATION</p> | | | | <p>V049-3-002 CABLE TRAY PLAN LOUISIANA RIGHT END STATION</p> | | | | <p>V049-3-003 LOUISIANA OVERALL SITE PLAN</p> | | | |
| <p>V049-3-001 GENERAL NOTES & LEGEND</p> | | | | <p>DO NOT SCALE THIS DRAWING 0 ISSUE FOR LA DESIGN REVIEW</p> | | | | <p>02.24.97 0430</p> | | | |
| <p>DWG. NO. DESCRIPTION REFERENCE DRAWINGS DESCRIPTION</p> | | | | <p>USED ON: REV DESCRIPTION</p> | | | | <p>CHKD: DRWN: DATE: DEOB:</p> | | | |
| <p>8 7 6 5 4 3 2 1</p> | | | | <p>SCALE 3/16" = 1' - 0"</p> | | | | <p>SHEET 1 OF 2</p> | | | |

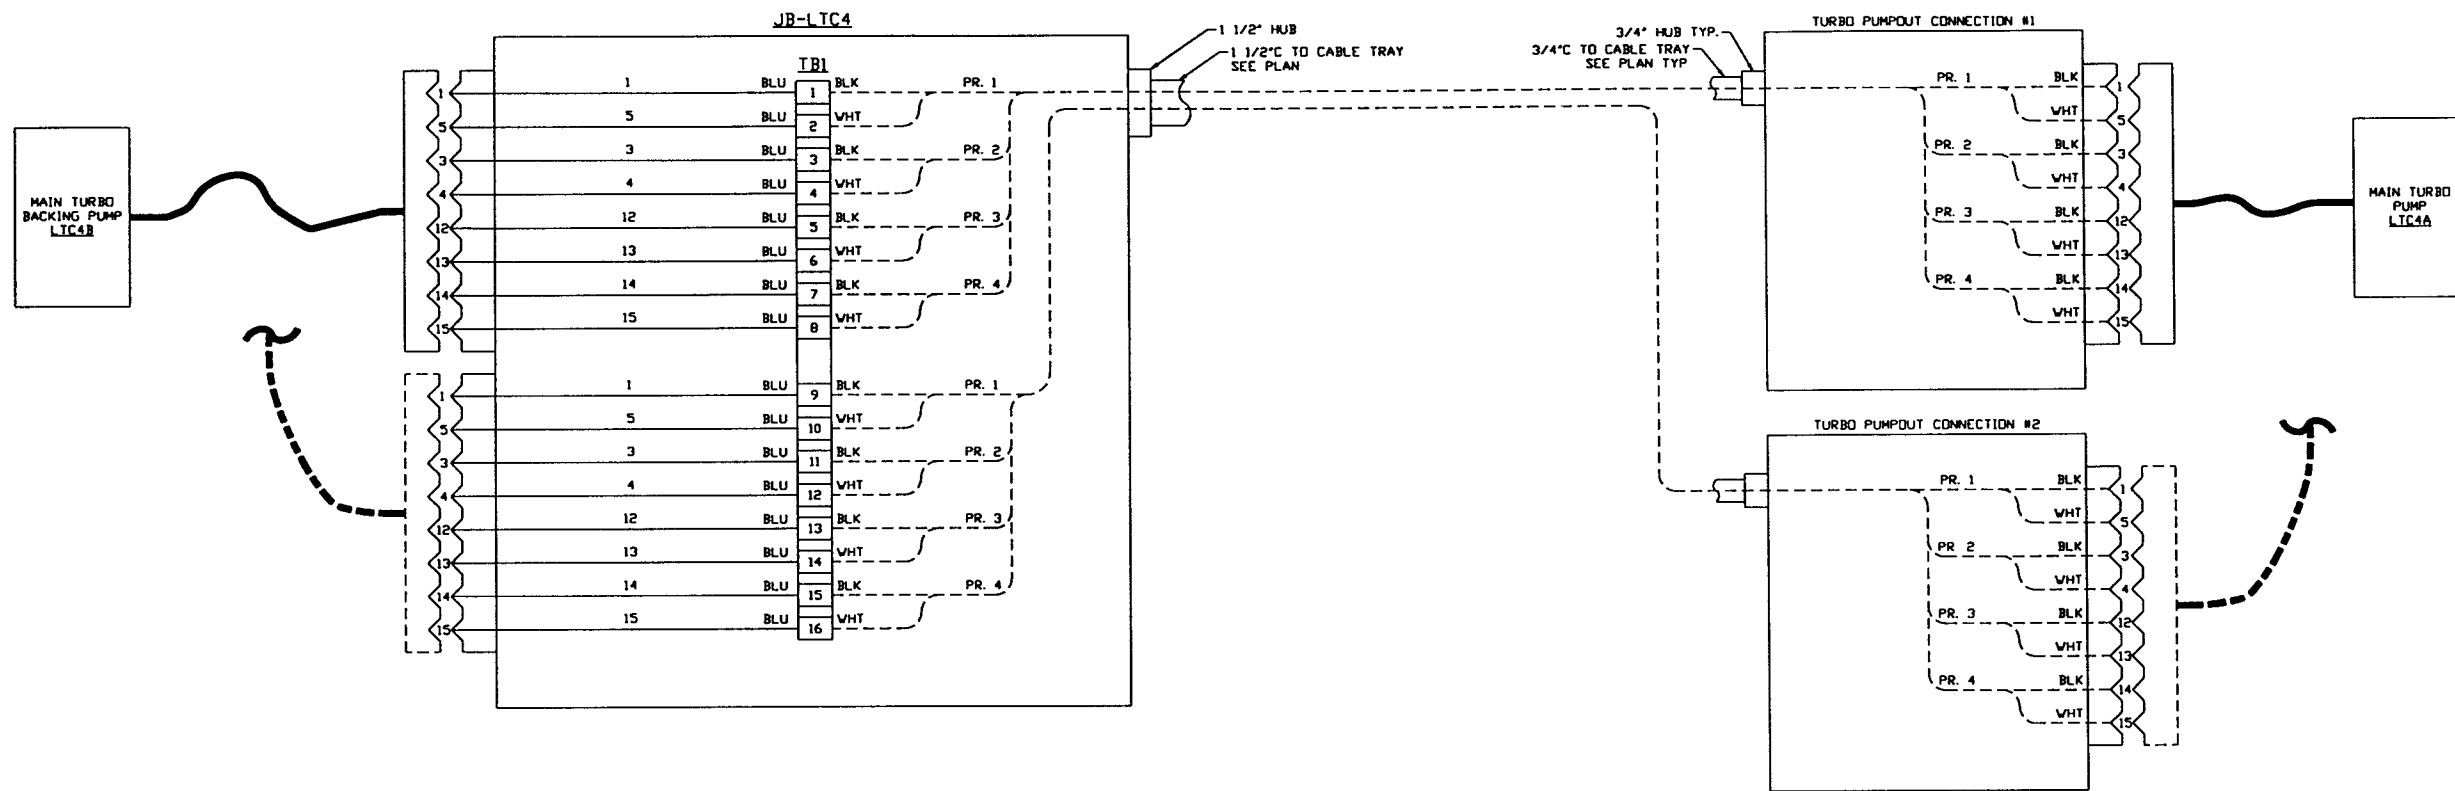

MAIN TURBO CART INTERFACE WIRING DIAGRAM

DETAIL 1 REF. V049-3-806
SCALE: NONE

PRELIMINARY NOT FOR CONSTRUCTION

SEE SHEET 1 FOR REVISIONS

| | | | |
|--|-----------------|------------------------|-----------|
| PROCESS SYSTEMS INTERNATIONAL INC. 20 WALRUP DR. WESTBOROUGH, MASSACHUSETTS 01581 USA | | | |
| VACUUM CARTS INTERFACE PLAN LIGO VACUUM EQUIPMENT LOUISIANA SITE RIGHT MID STATION | | | |
| CAD FILE V0493806\380652 | SIZE D | DWG. NO. V049-3-806 | REV. 0 |
| SCALE NONE | SHEET 2 OF 2 | | |

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