



NOTES:

- 1.) FOR GENERAL NOTES & LEGEND SEE PSI DWG. #V049-3-001 SHT. 1.
- 2.) FOR LIST OF CIVIL CONTRACTOR REFERENCE DWGS. WITH CURRENT REVISIONS SEE PSI DWG. #V049-3-001 SHT. 2.
- 3.) CONDUIT IS SHOWN DIAGRAMMATICALLY AND SHALL BE FIELD VERIFIED SO AS TO OPTIMIZE SUPPORTING MEANS AND TO AVOID INTERFERENCES WITH PIPING SYSTEMS.
- 4.) IDENTIFY ALL CONNECTION BOXES WITH BLACK PHENOLIC TAGS WITH WHITE LETTERING. LETTERING SHALL BE 3/8" HIGH.
- 5.) ALL CONDUIT SHALL BE EMT UNLESS OTHERWISE NOTED.

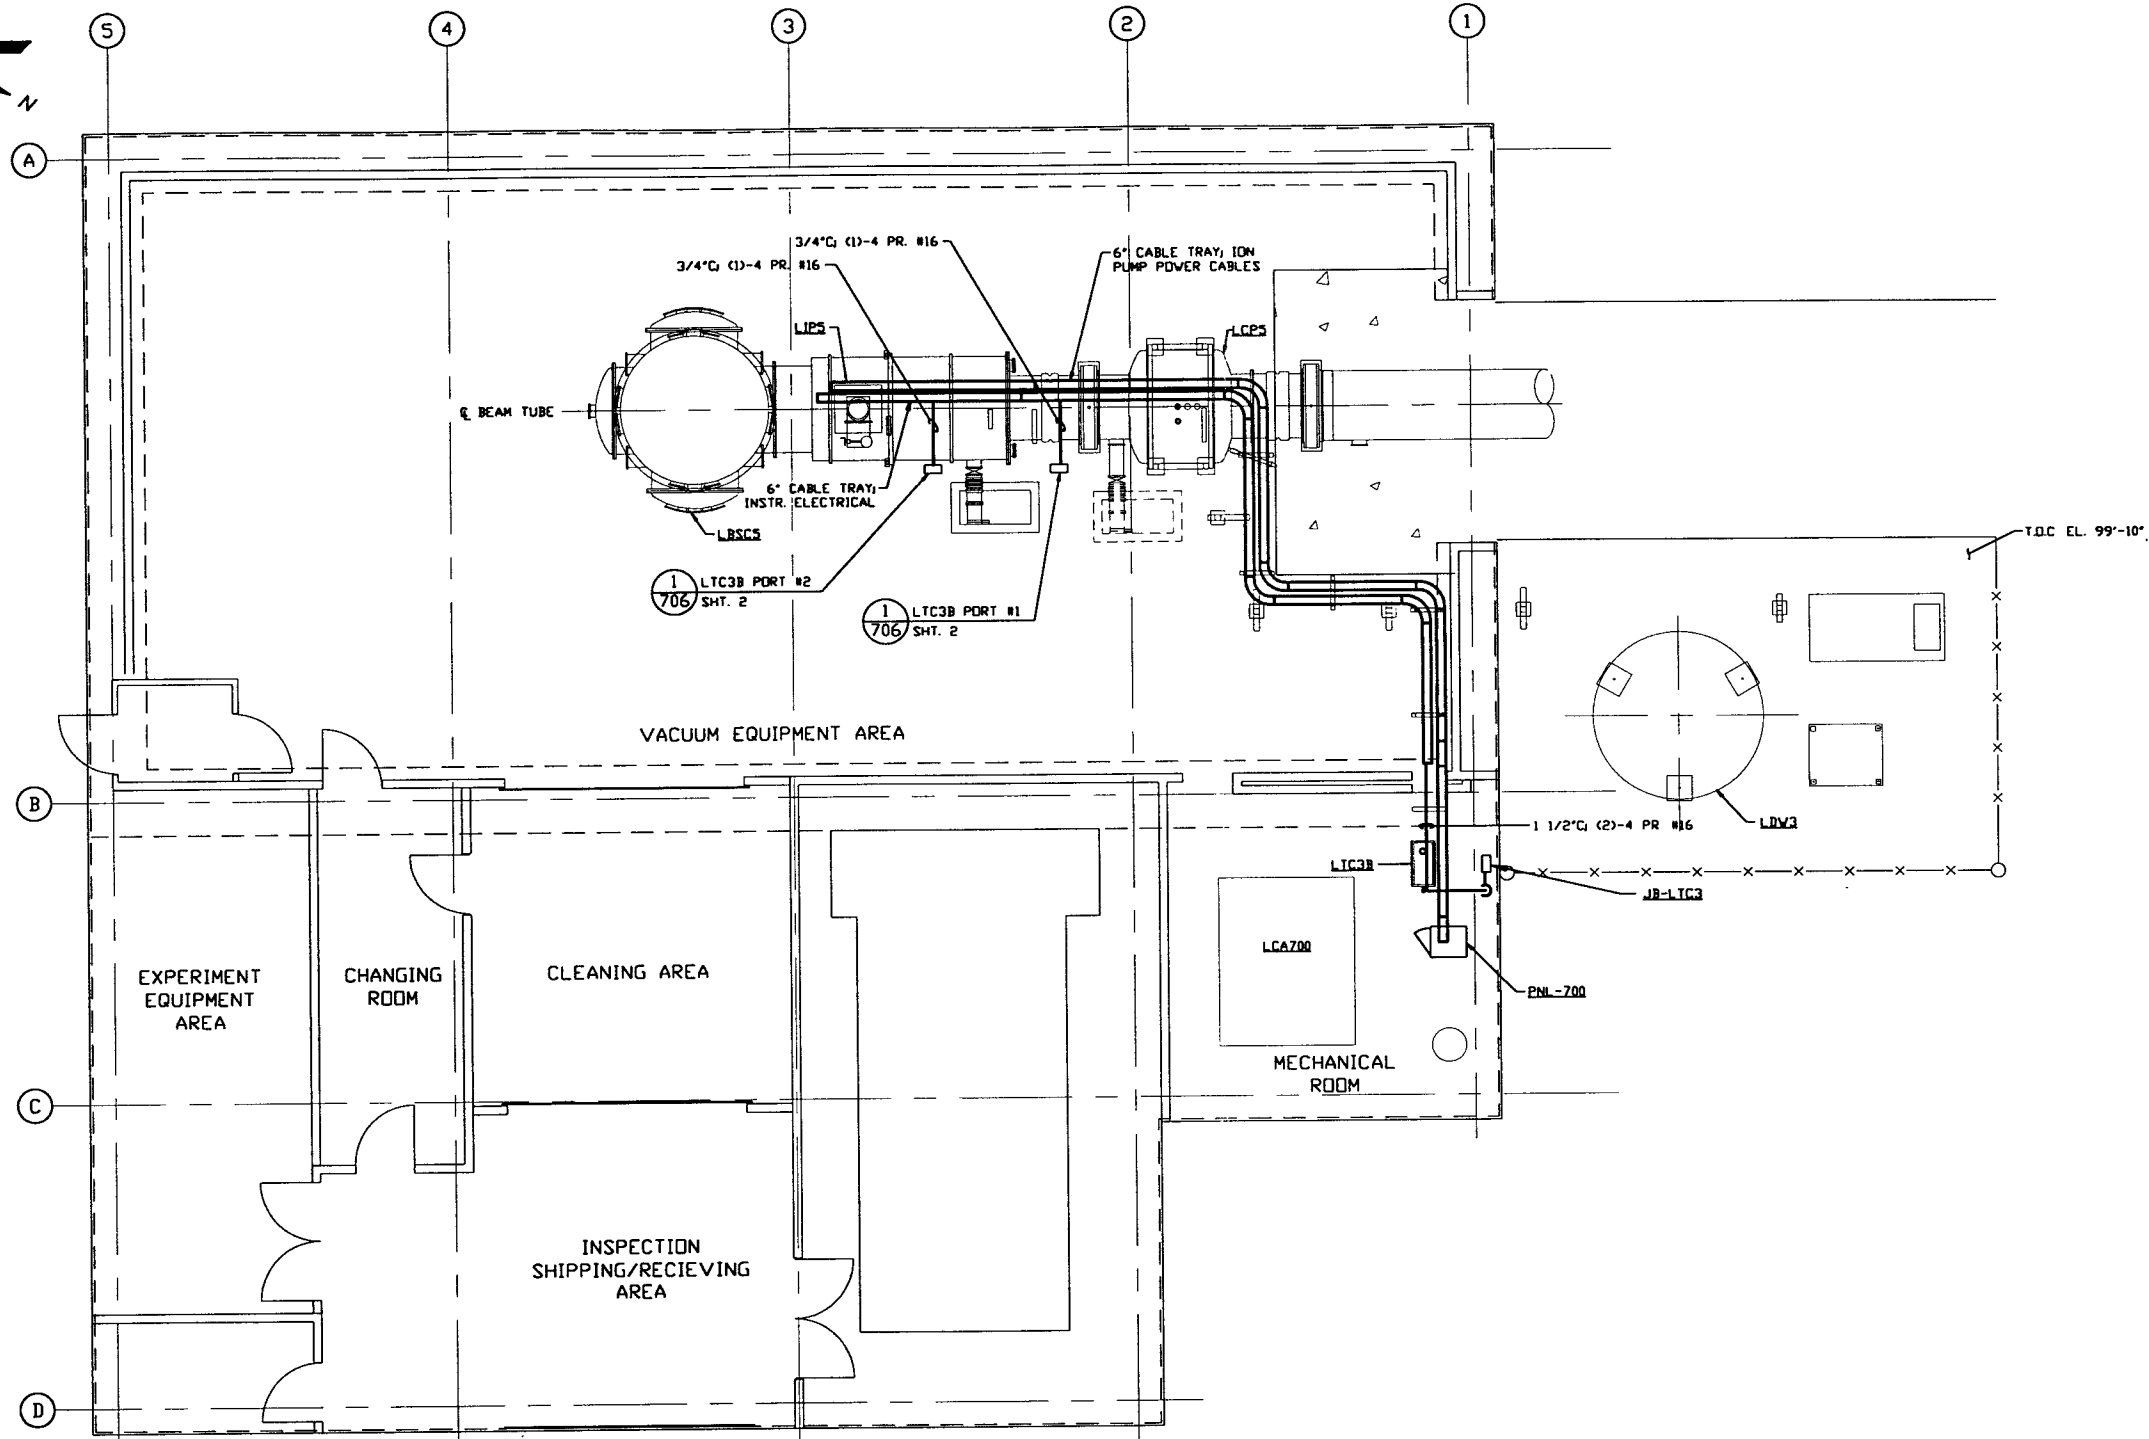

LEFT END STATION PLAN @ EL. 100'-0"

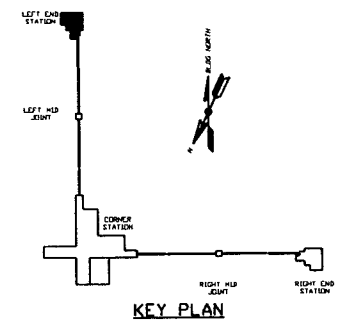

PRELIMINARY NOT FOR CONSTRUCTION


LIGO-D970141-00-V

PROPRIETARY AND CONFIDENTIAL THIS DOCUMENT CONTAINS PROPRIETARY INFORMATION BELONGING TO PROCESS SYSTEMS INTERNATIONAL, INC. OR ITS AFFILIATED COMPANIES AND SHALL BE USED ONLY FOR THE PURPOSE FOR WHICH IT WAS SUPPLIED. IT SHALL NOT BE COPIED, REPRODUCED OR OTHERWISE USED, NOR SHALL SUCH INFORMATION BE FURNISHED IN WHOLE OR IN PART TO OTHERS EXCEPT IN ACCORDANCE WITH THE TERMS OF ANY AGREEMENT UNDER WHICH IT WAS SUPPLIED OR WITH THE PRIOR WRITTEN CONSENT OF PROCESS SYSTEMS INTERNATIONAL, INC. AND SHALL BE RETURNED UPON REQUEST.						UNLESS OTHERWISE SPECIFIED DIMENSIONS ARE IN INCHES TOLERANCES: FRACTIONAL & ANGULAR DIMENSION 80"-30" NOM 12" TWO PLACE DECIMAL & IN THREE PLACE DECIMAL & .005 FINISHED SURFACE DIMS BREAK CORNERS TO OUT- REMOVE ALL BURRS					
V049-3-009	EQUIP. ARRANGEMENT LEFT END STATION		V049-3-702	CABLE TRAY PLAN LOUISIANA LEFT END STATION							
V049-3-003	LOUISIANA OVERALL SITE PLAN		V049-3-001	GENERAL NOTES & LEGEND							
DWG. NO.	DESCRIPTION	DWG. NO.	DESCRIPTION	DO NOT SCALE THIS DRAWING	0	ISSUE FOR LA DESIGN REVIEW				02.24.97	0430
				USED ON:	REV	DESCRIPTION	CHKD	DRWN	DATE	DEDN	
				NEXT ASS'Y:							
REFERENCE DRAWINGS 7 6 5 4 3 2 1							SCALE 3/16" = 1' - 0" SHEET 1 OF 2				

PROCESS SYSTEMS INTERNATIONAL, INC.
 20 WALKUP DR. WESTBOROUGH, MASSACHUSETTS 01581 USA

**VACUUM CART INTERFACE PLAN
 LIGO VACUUM EQUIPMENT
 LOUISIANA SITE
 LEFT END STATION**

CAD FILE: V0493706/3706SI SIZE: D DWG. NO.: V049-3-706 REV. 0

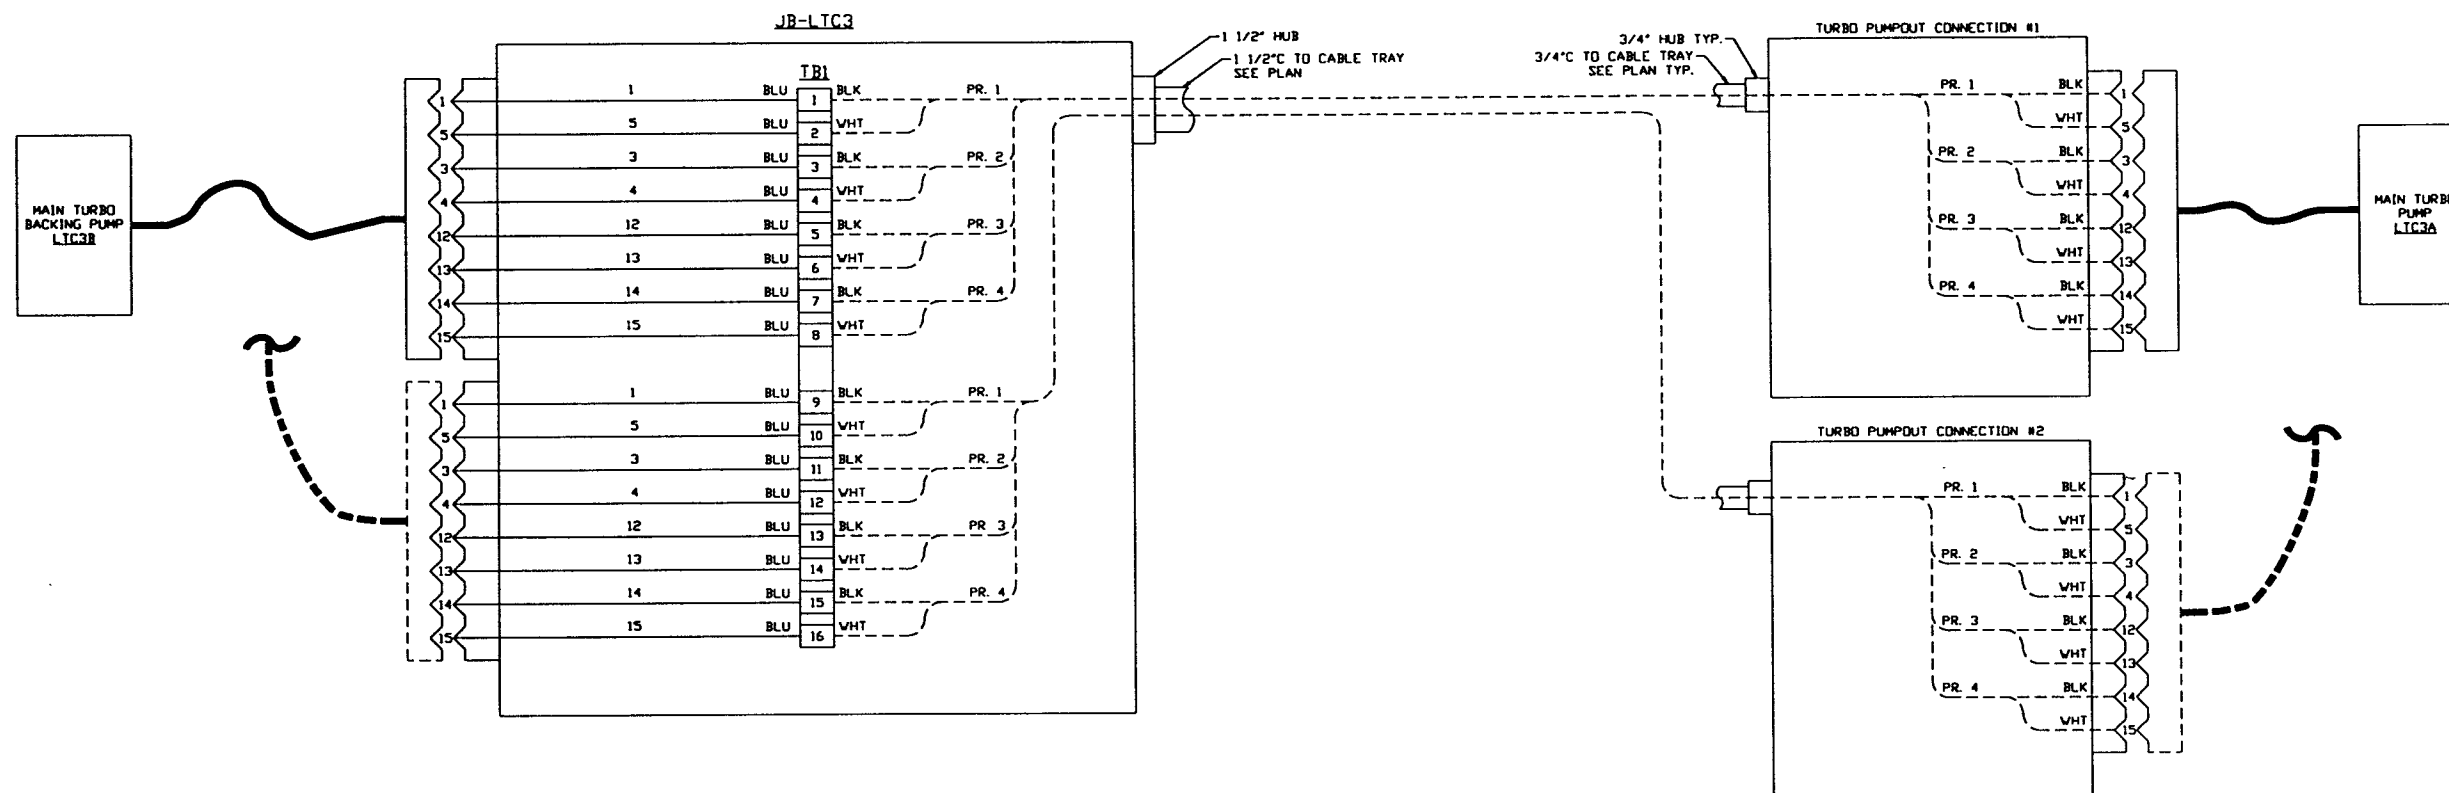

MAIN TURBO CART INTERFACE WIRING DIAGRAM

DETAIL 1 REF
SCALE: NONE V049-3-706

PRELIMINARY NOT FOR CONSTRUCTION

SEE SHEET 1 FOR REVISIONS

PROCESS SYSTEMS INTERNATIONAL INC. 20 WALKUP DR. WESTBOROUGH, MASSACHUSETTS 01581 USA			
VACUUM CARTS INTERFACE PLAN LIGO VACUUM EQUIPMENT LOUISIANA SITE LEFT END STATION			
CAB FILE	SIZE	DRG. NO.	REV.
V0493706\3706S2	D	V049-3-706	0
SCALE	NONE	SHEET	2 OF 2

LIGO-D970141-00-V