





NOTES:
1. SEE SHEET RG-C-002 FOR GENERAL NOTES, LEGEND AND ABBREVIATIONS.

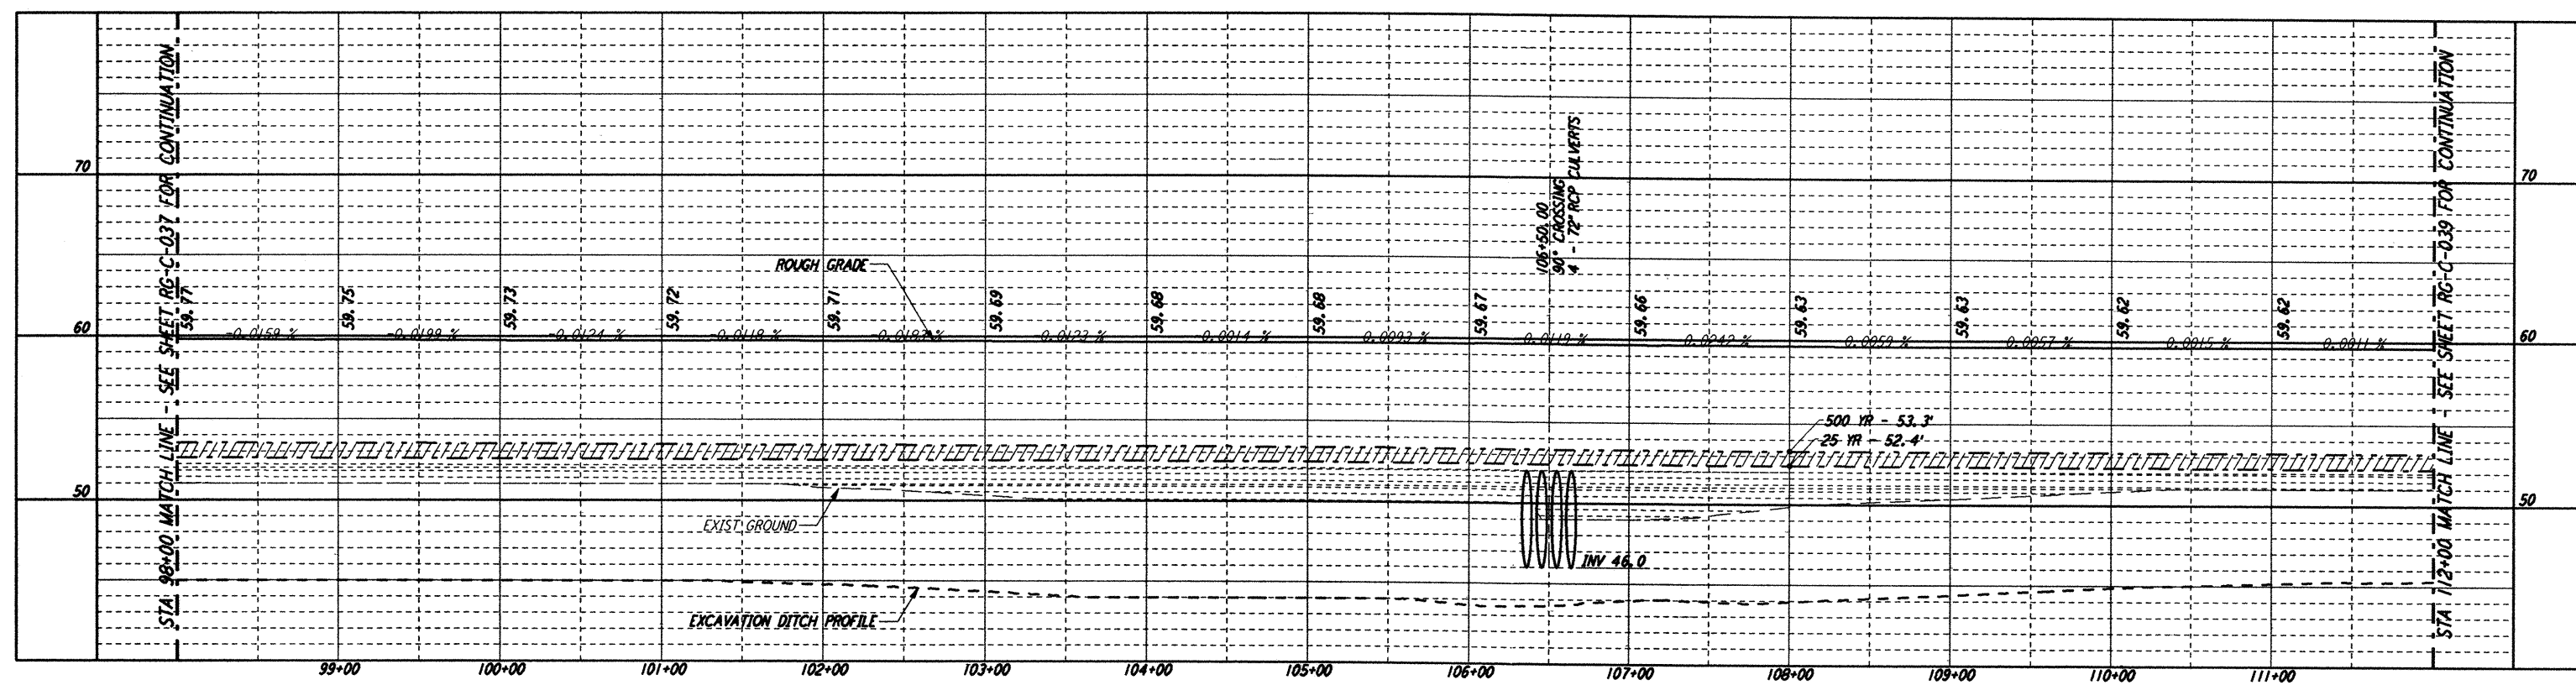

PROFILE
SCALE: HORIZ: 1" = 50'
VERT: 1" = 5'

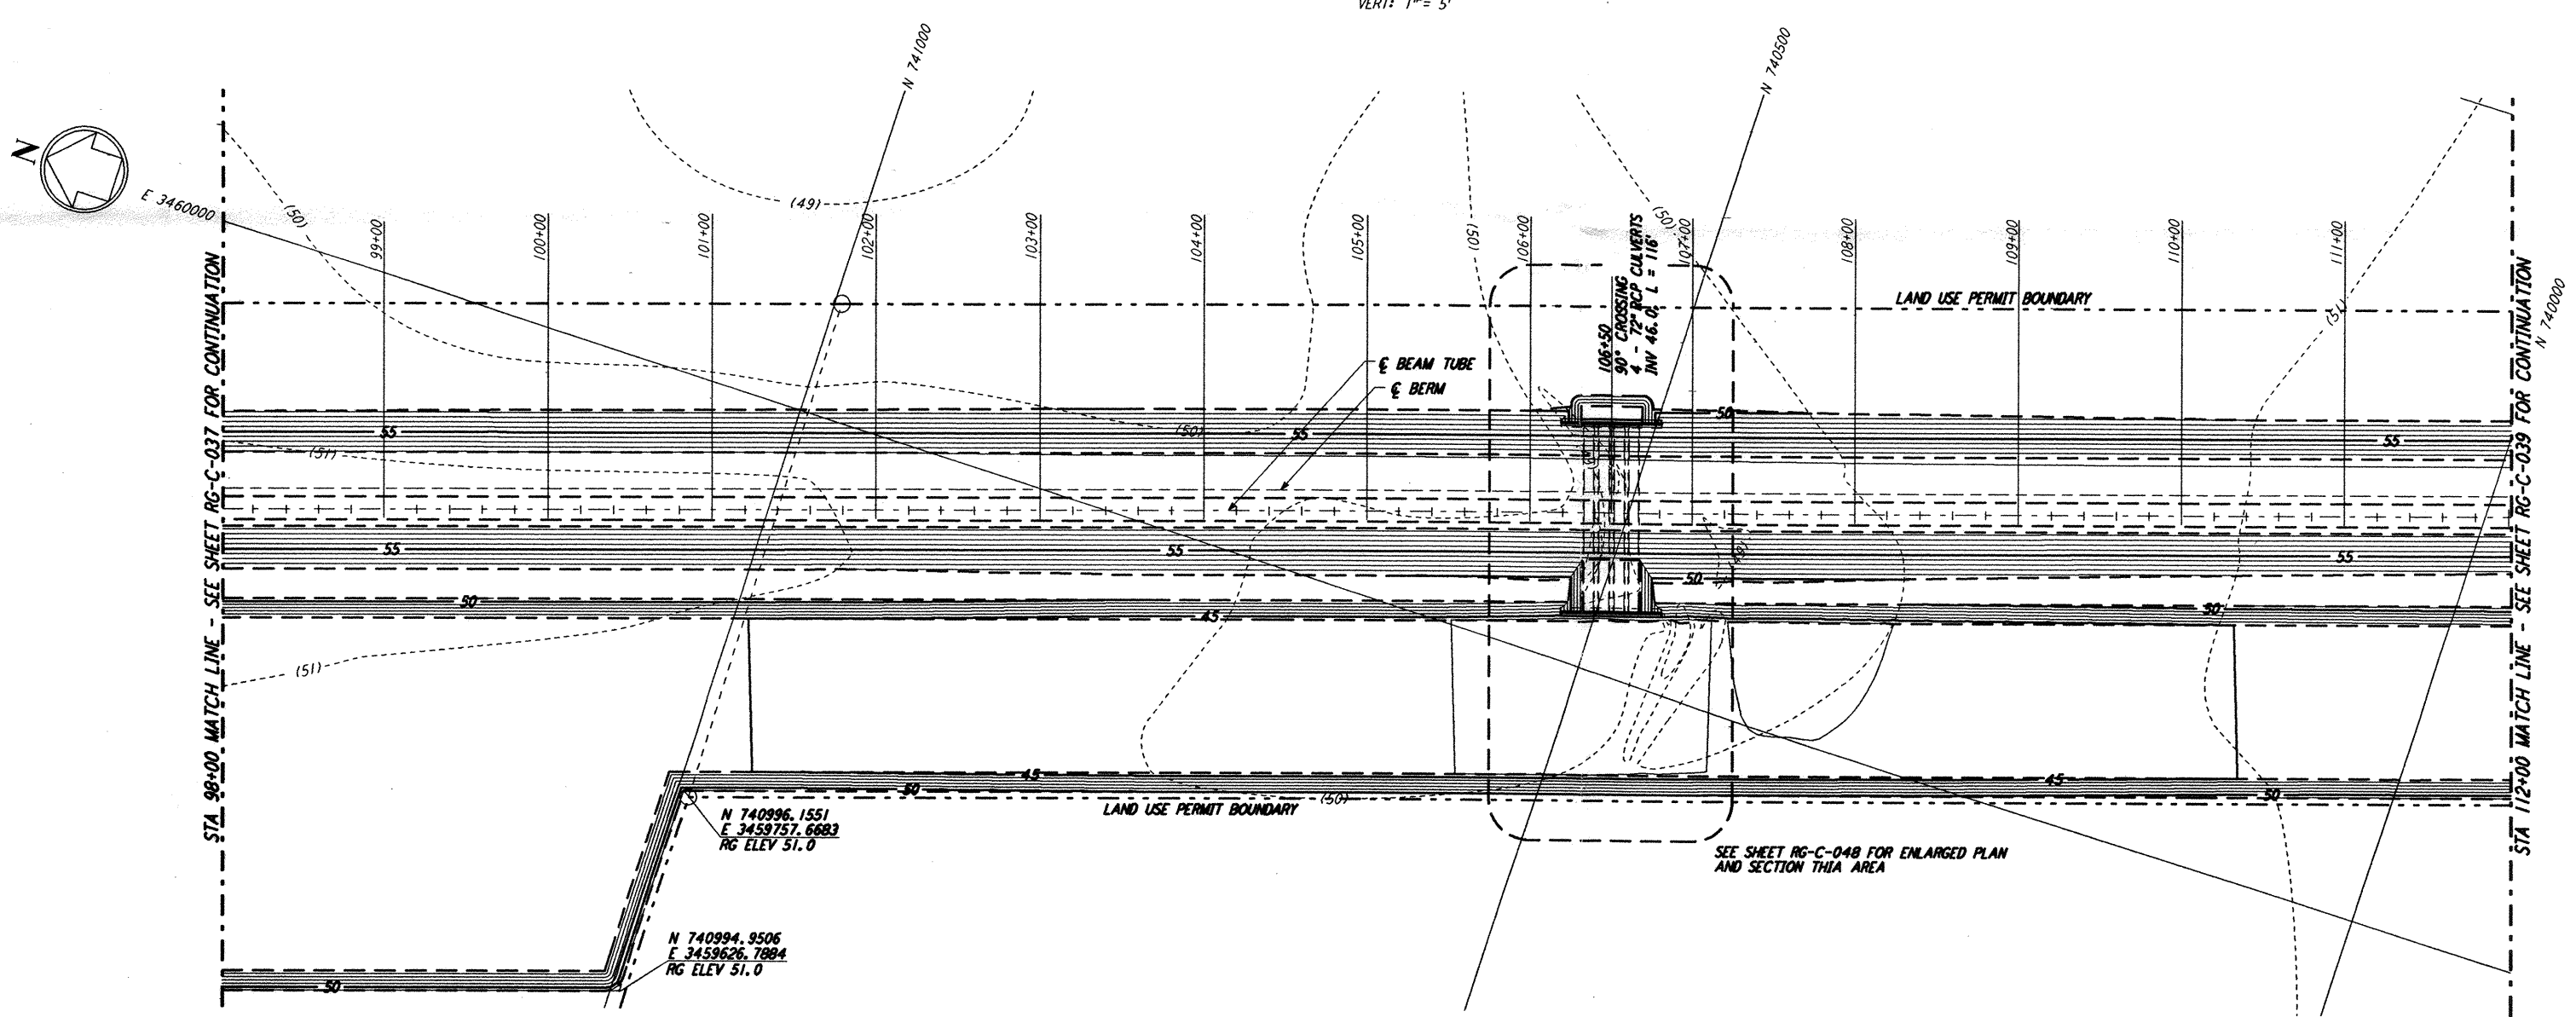

PLAN
SCALE: 1" = 50'

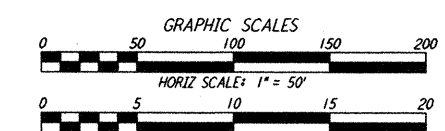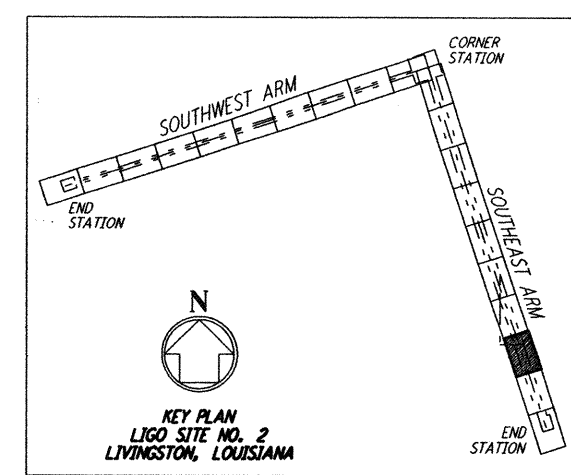

LIGO-0961743-2

**LASER INTERFEROMETER
GRAVITATIONAL-WAVE OBSERVATORY
ROUGH GRADING - LIVINGSTON, LA**

TITLE	AS NOTED	CONTRACT NUMBER	PROJECT NUMBER
ROUGH GRADING SOUTHEAST ARM PLAN AND PROFILE STA 98+00 TO STA 112+00	PP150969	8094	
SHEET NUMBER		REVISION	
RG-C-038			

PARSONS

100 WEST WALNUT STREET
PASADENA, CALIFORNIA

LIGO

CALIFORNIA INSTITUTE OF TECHNOLOGY
MASSACHUSETTS INSTITUTE OF TECHNOLOGY

NO.	DATE	APRD BY	DESCRIPTION OF REVISION	NO.	DATE	APRD BY	ISSUED FOR
9				9			
8				8			
7				7			
6				6			
5				5			
4				4			
3				3			
2				2			
1	8/11/95	JJB	FINAL DESIGN REVIEW	1	8/11/95	JJB	FINAL DESIGN REVIEW

This document and the design it covers are the property of PARSONS. They are loaned only with the borrower's expressed written agreement that they will not be reproduced, copied, loaned, exhibited, or used in any other way, except by written consent from PARSONS to the borrower.