


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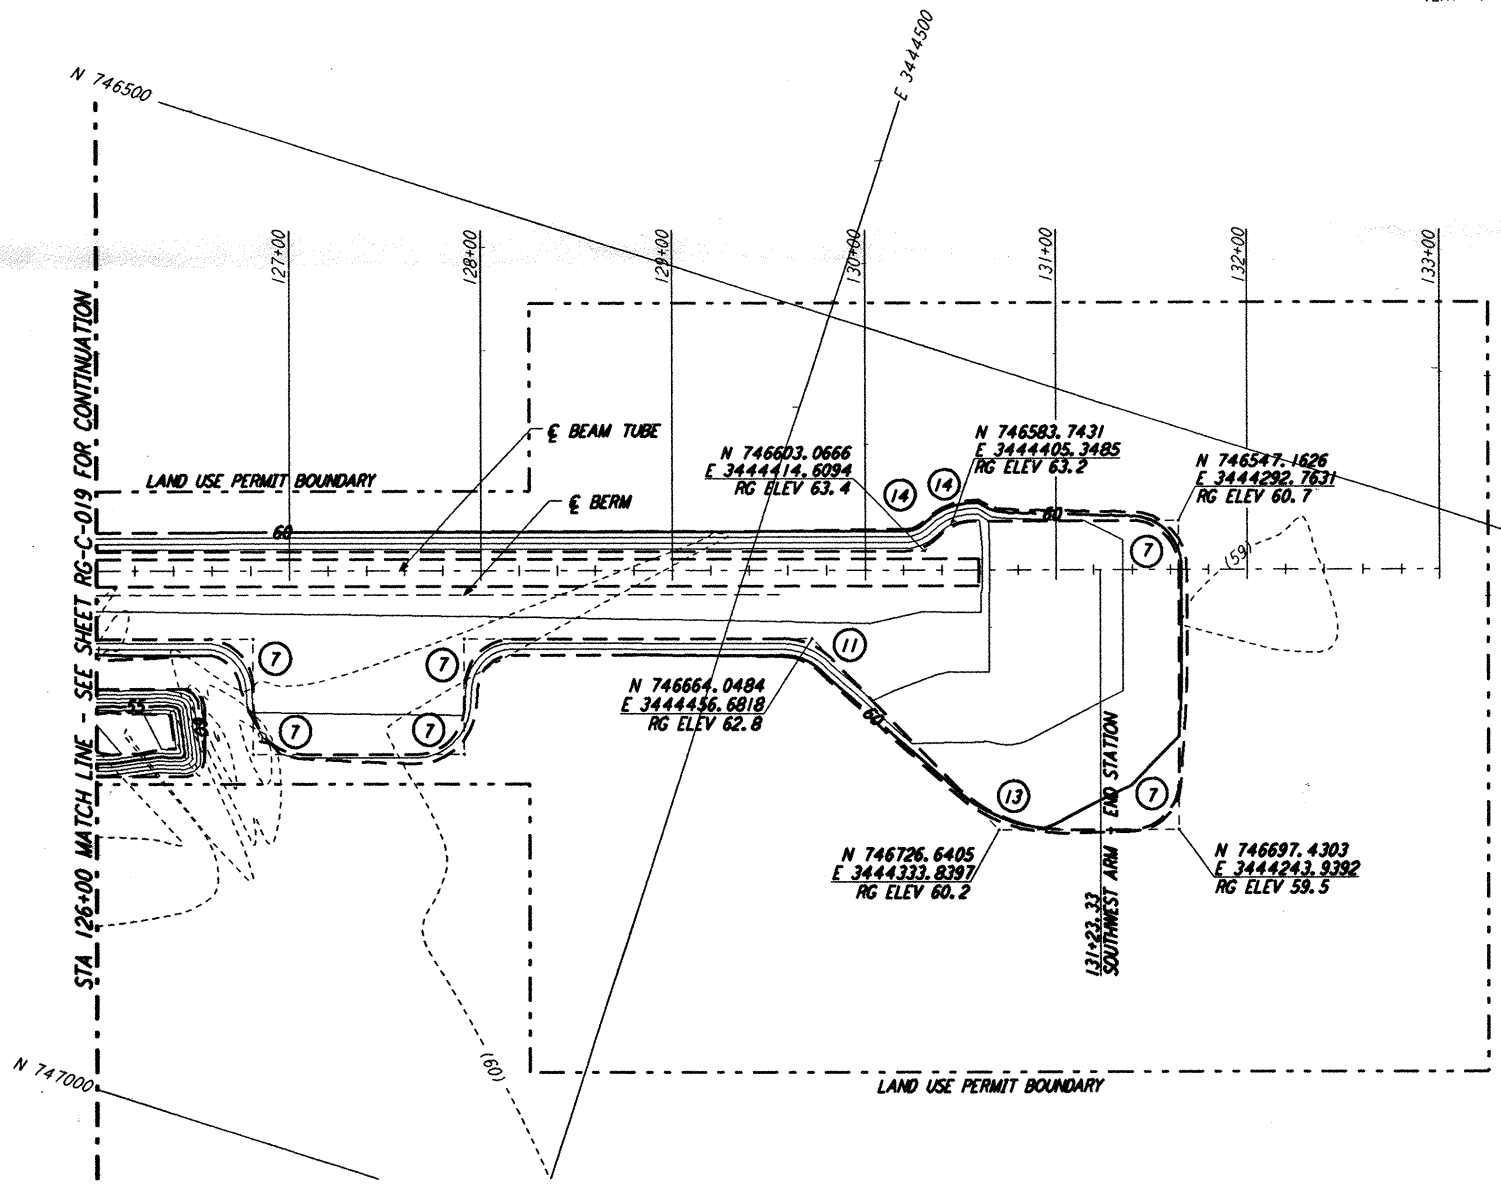
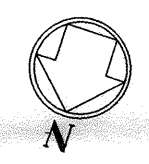
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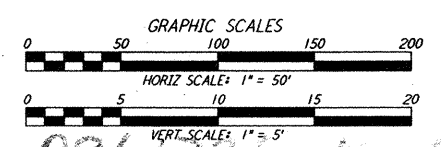
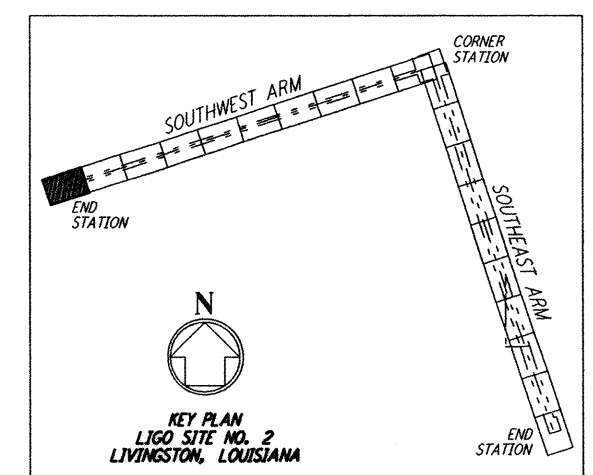
PROFILE
SCALE: HORIZ: 1" = 50'
VERT: 1" = 5'

NOTES:
1. SEE SHEET RG-C-002 FOR GENERAL NOTES, LEGEND AND ABBREVIATIONS.

CURVE DATA				
Δ	RADIUS	LENGTH	TANGENT	
7	90°00'00"	25.00'	39.27'	25.00'
11	45°00'00"	39.00'	30.63'	16.16'
13	45°00'00"	81.00'	63.62'	33.55'
14	46°23'52"	25.00'	20.24'	10.71'

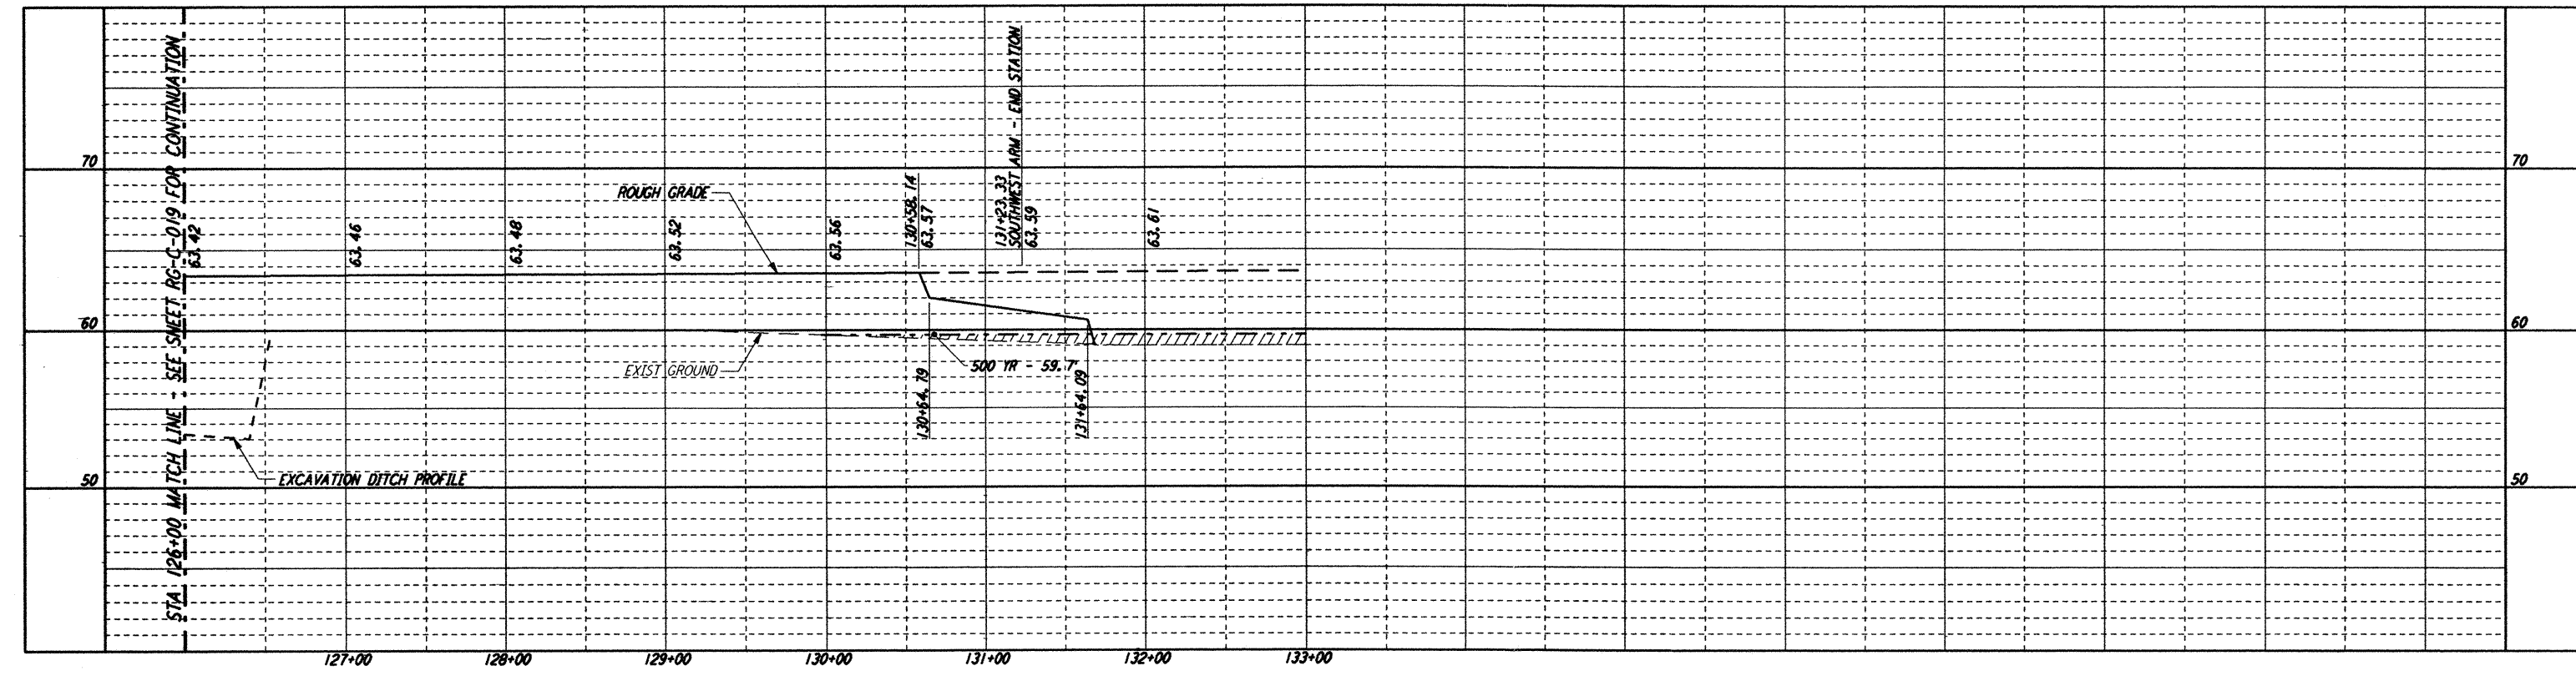

PLAN
SCALE: 1" = 50'



NO.	DATE	APRD BY	DESCRIPTION OF REVISION
9			
8			
7			
6			
5			
4			
3			
2			
1			

NO.	DATE	APRD BY	ISSUED FOR
9			
8			
7			
6			
5			
4			
3			
2	8/11/95	JUB	FINAL DESIGN REVIEW
1			

DATE	8/11/95
DRAWN	WRB
CHECKED	MGP
SECT HD	
PROJ MGR	
CLIENT	

PARSONS
100 WEST WALNUT STREET
PASADENA, CALIFORNIA

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CALIFORNIA INSTITUTE OF TECHNOLOGY
MASSACHUSETTS INSTITUTE OF TECHNOLOGY

LASER INTERFEROMETER GRAVITATIONAL-WAVE OBSERVATORY ROUGH GRADING - LIVINGSTON, LA

TITLE: ROUGH GRADING SOUTHWEST ARM PLAN AND PROFILE STA 126+00 TO STA 133+00

SCALE: AS NOTED

CONTRACT NUMBER: PP150969

PROJECT NUMBER: 8094

SHEET NUMBER: RG-C-020