


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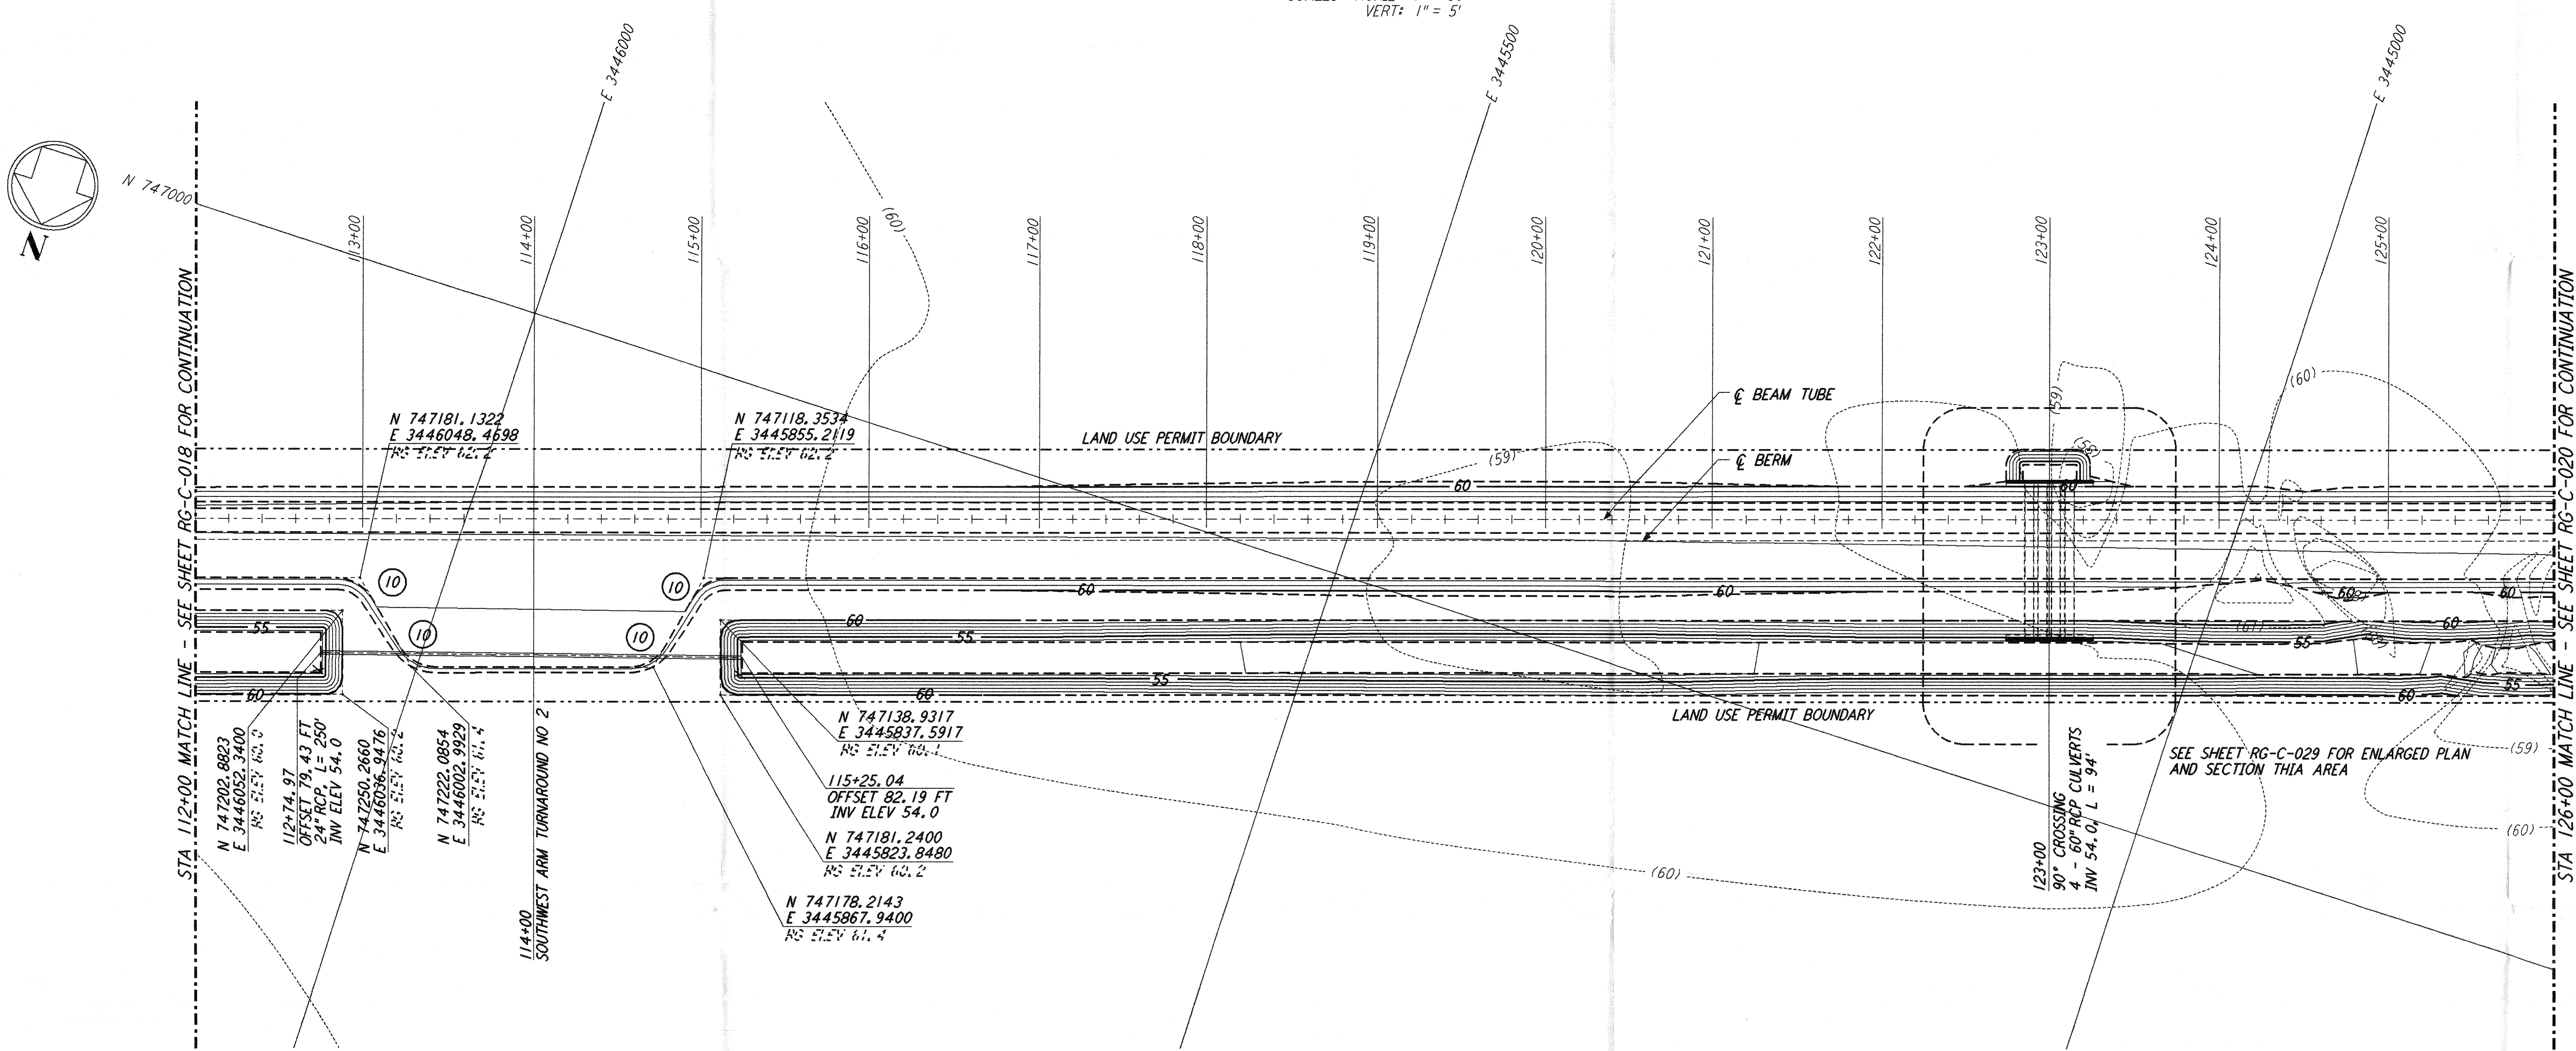
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NOTES:
 1. SEE SHEET RG-C-002 FOR GENERAL NOTES, LEGEND AND ABBREVIATIONS.


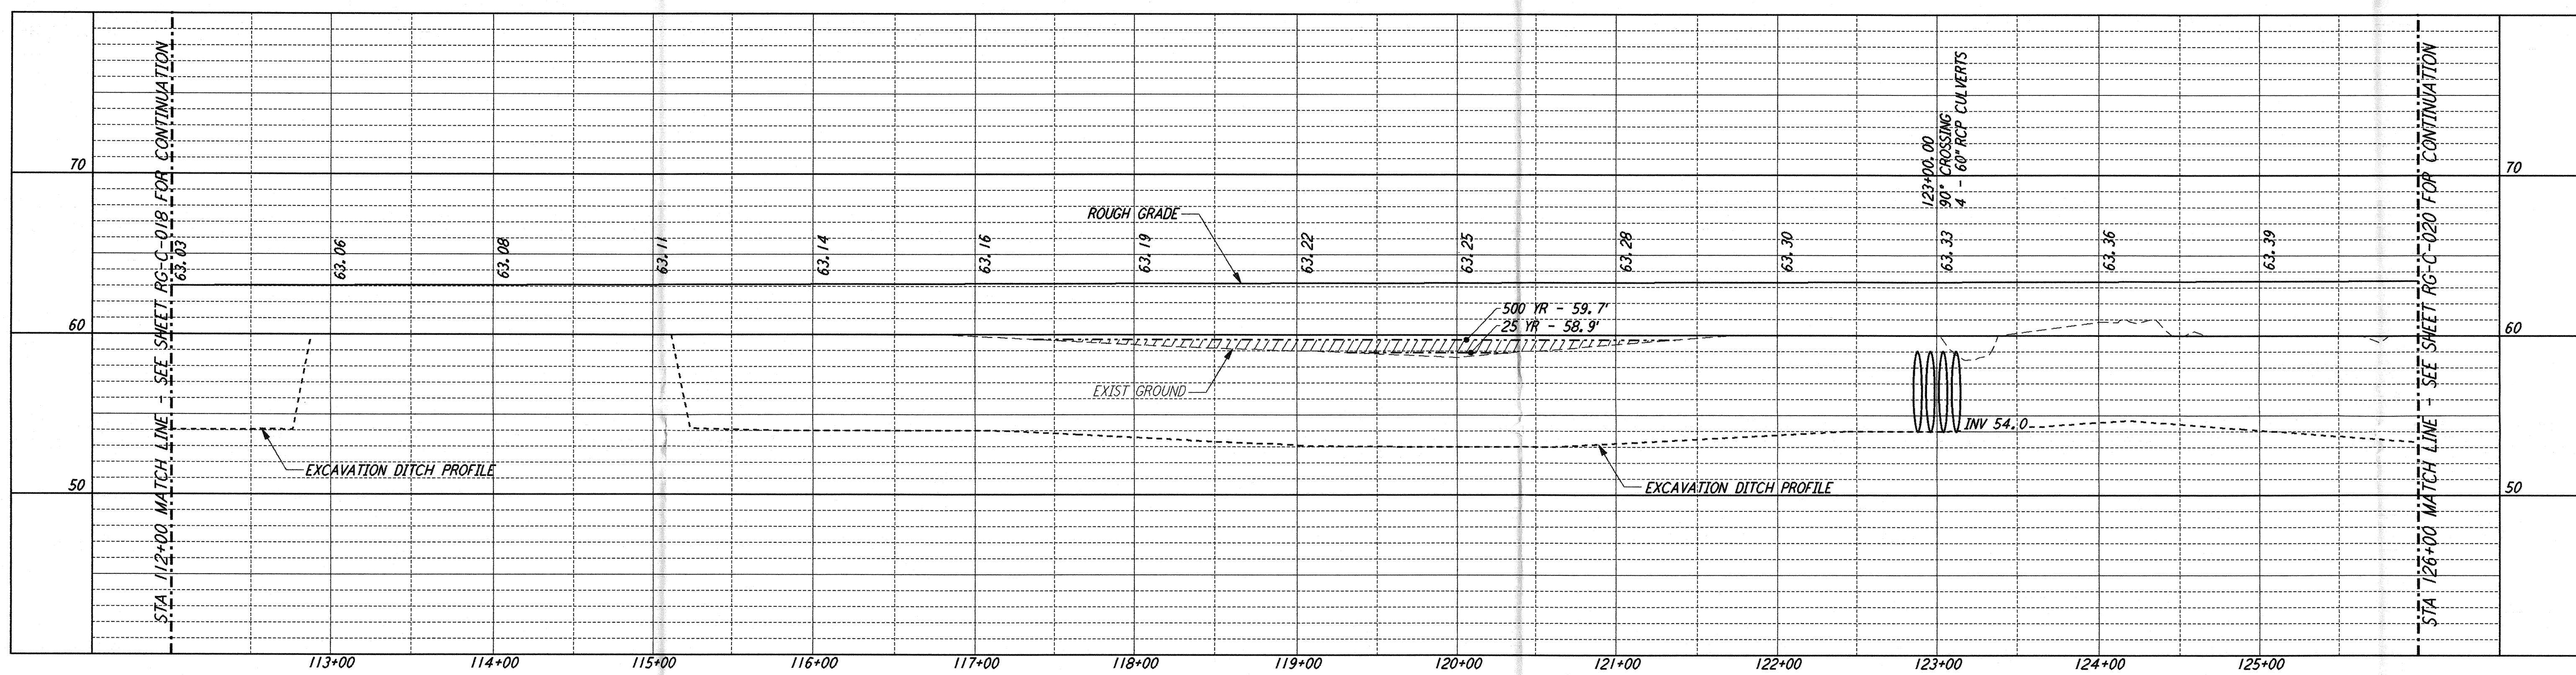


CURVE DATA				
Δ	RADIUS	LENGTH	TANGENT	
10	60°00'00"	25.00'	26.18'	14.43'

PROFILE
 SCALES: HORIZ: 1" = 50'
 VERT: 1" = 5'



PLAN
 SCALE: 1" = 50'

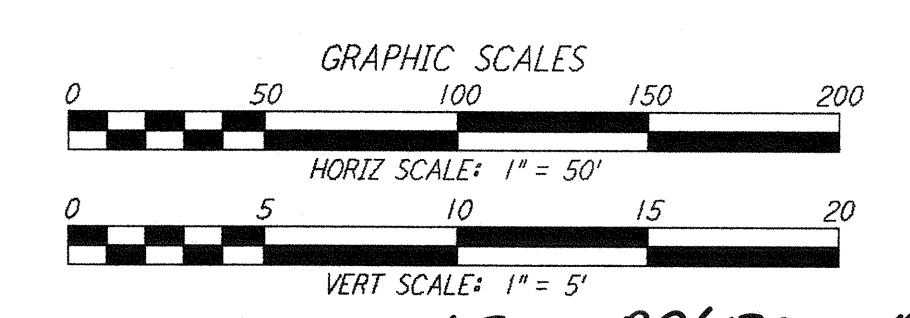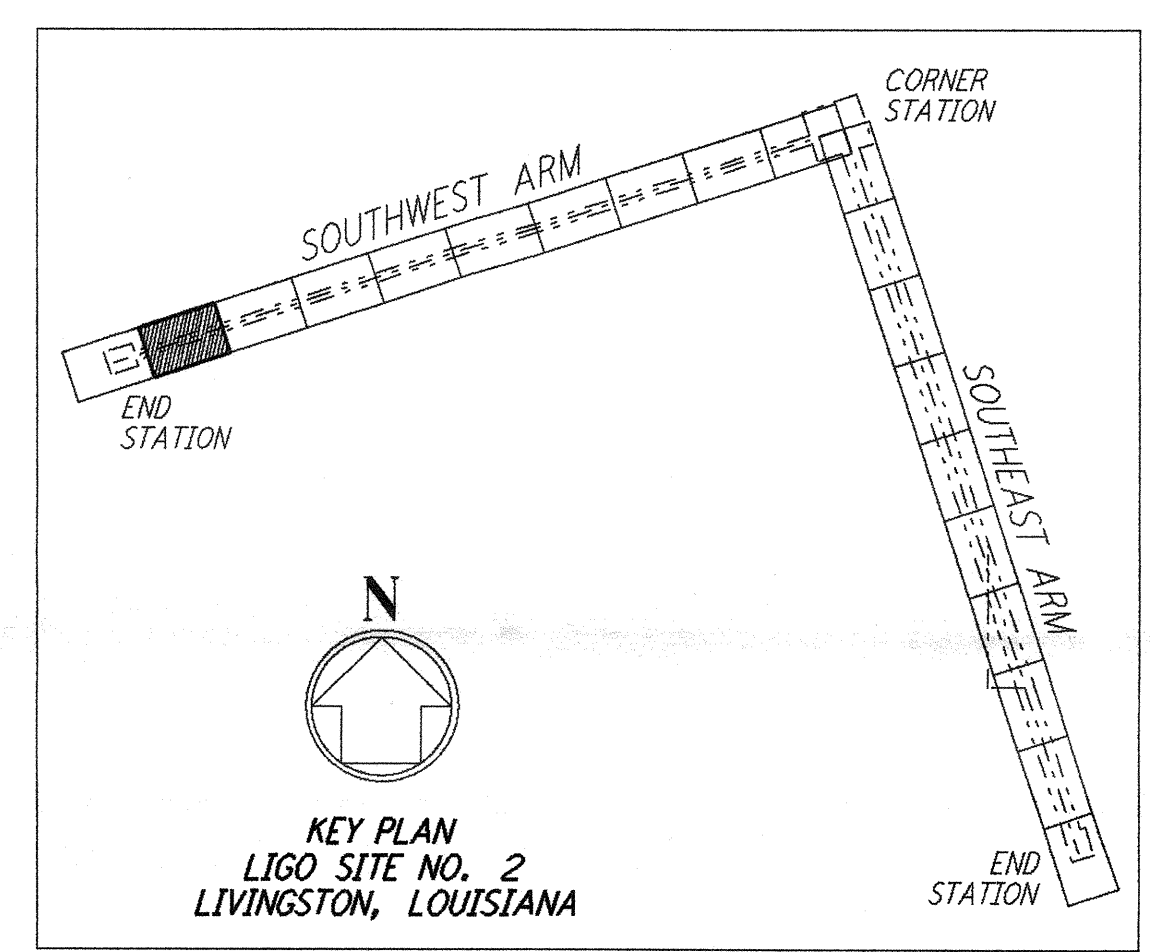

NO.	DATE	APRD BY	DESCRIPTION OF REVISION
9			
8			
7			
6			
5			
4			
3			
2			
1			

NO.	DATE	APRD BY	ISSUED FOR
1	8/11/95	JLB	FINAL DESIGN REVIEW

DATE	8/11/95
DRAWN	WRB VPS
CHECKED	MGP
SECT HD	
PROJ MGR	
CLIENT	

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 PASADENA, CALIFORNIA

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 MASSACHUSETTS INSTITUTE OF TECHNOLOGY

LASER INTERFEROMETER
 GRAVITATIONAL-WAVE OBSERVATORY
ROUGH GRADING - LIVINGSTON, LA

TITLE	AS NOTED	CONTRACT NUMBER	PROJECT NUMBER
ROUGH GRADING SOUTHWEST ARM PLAN AND PROFILE STA 112+00 TO STA 126+00	PP150969	8094	

SHEET NUMBER: **RG-C-019**