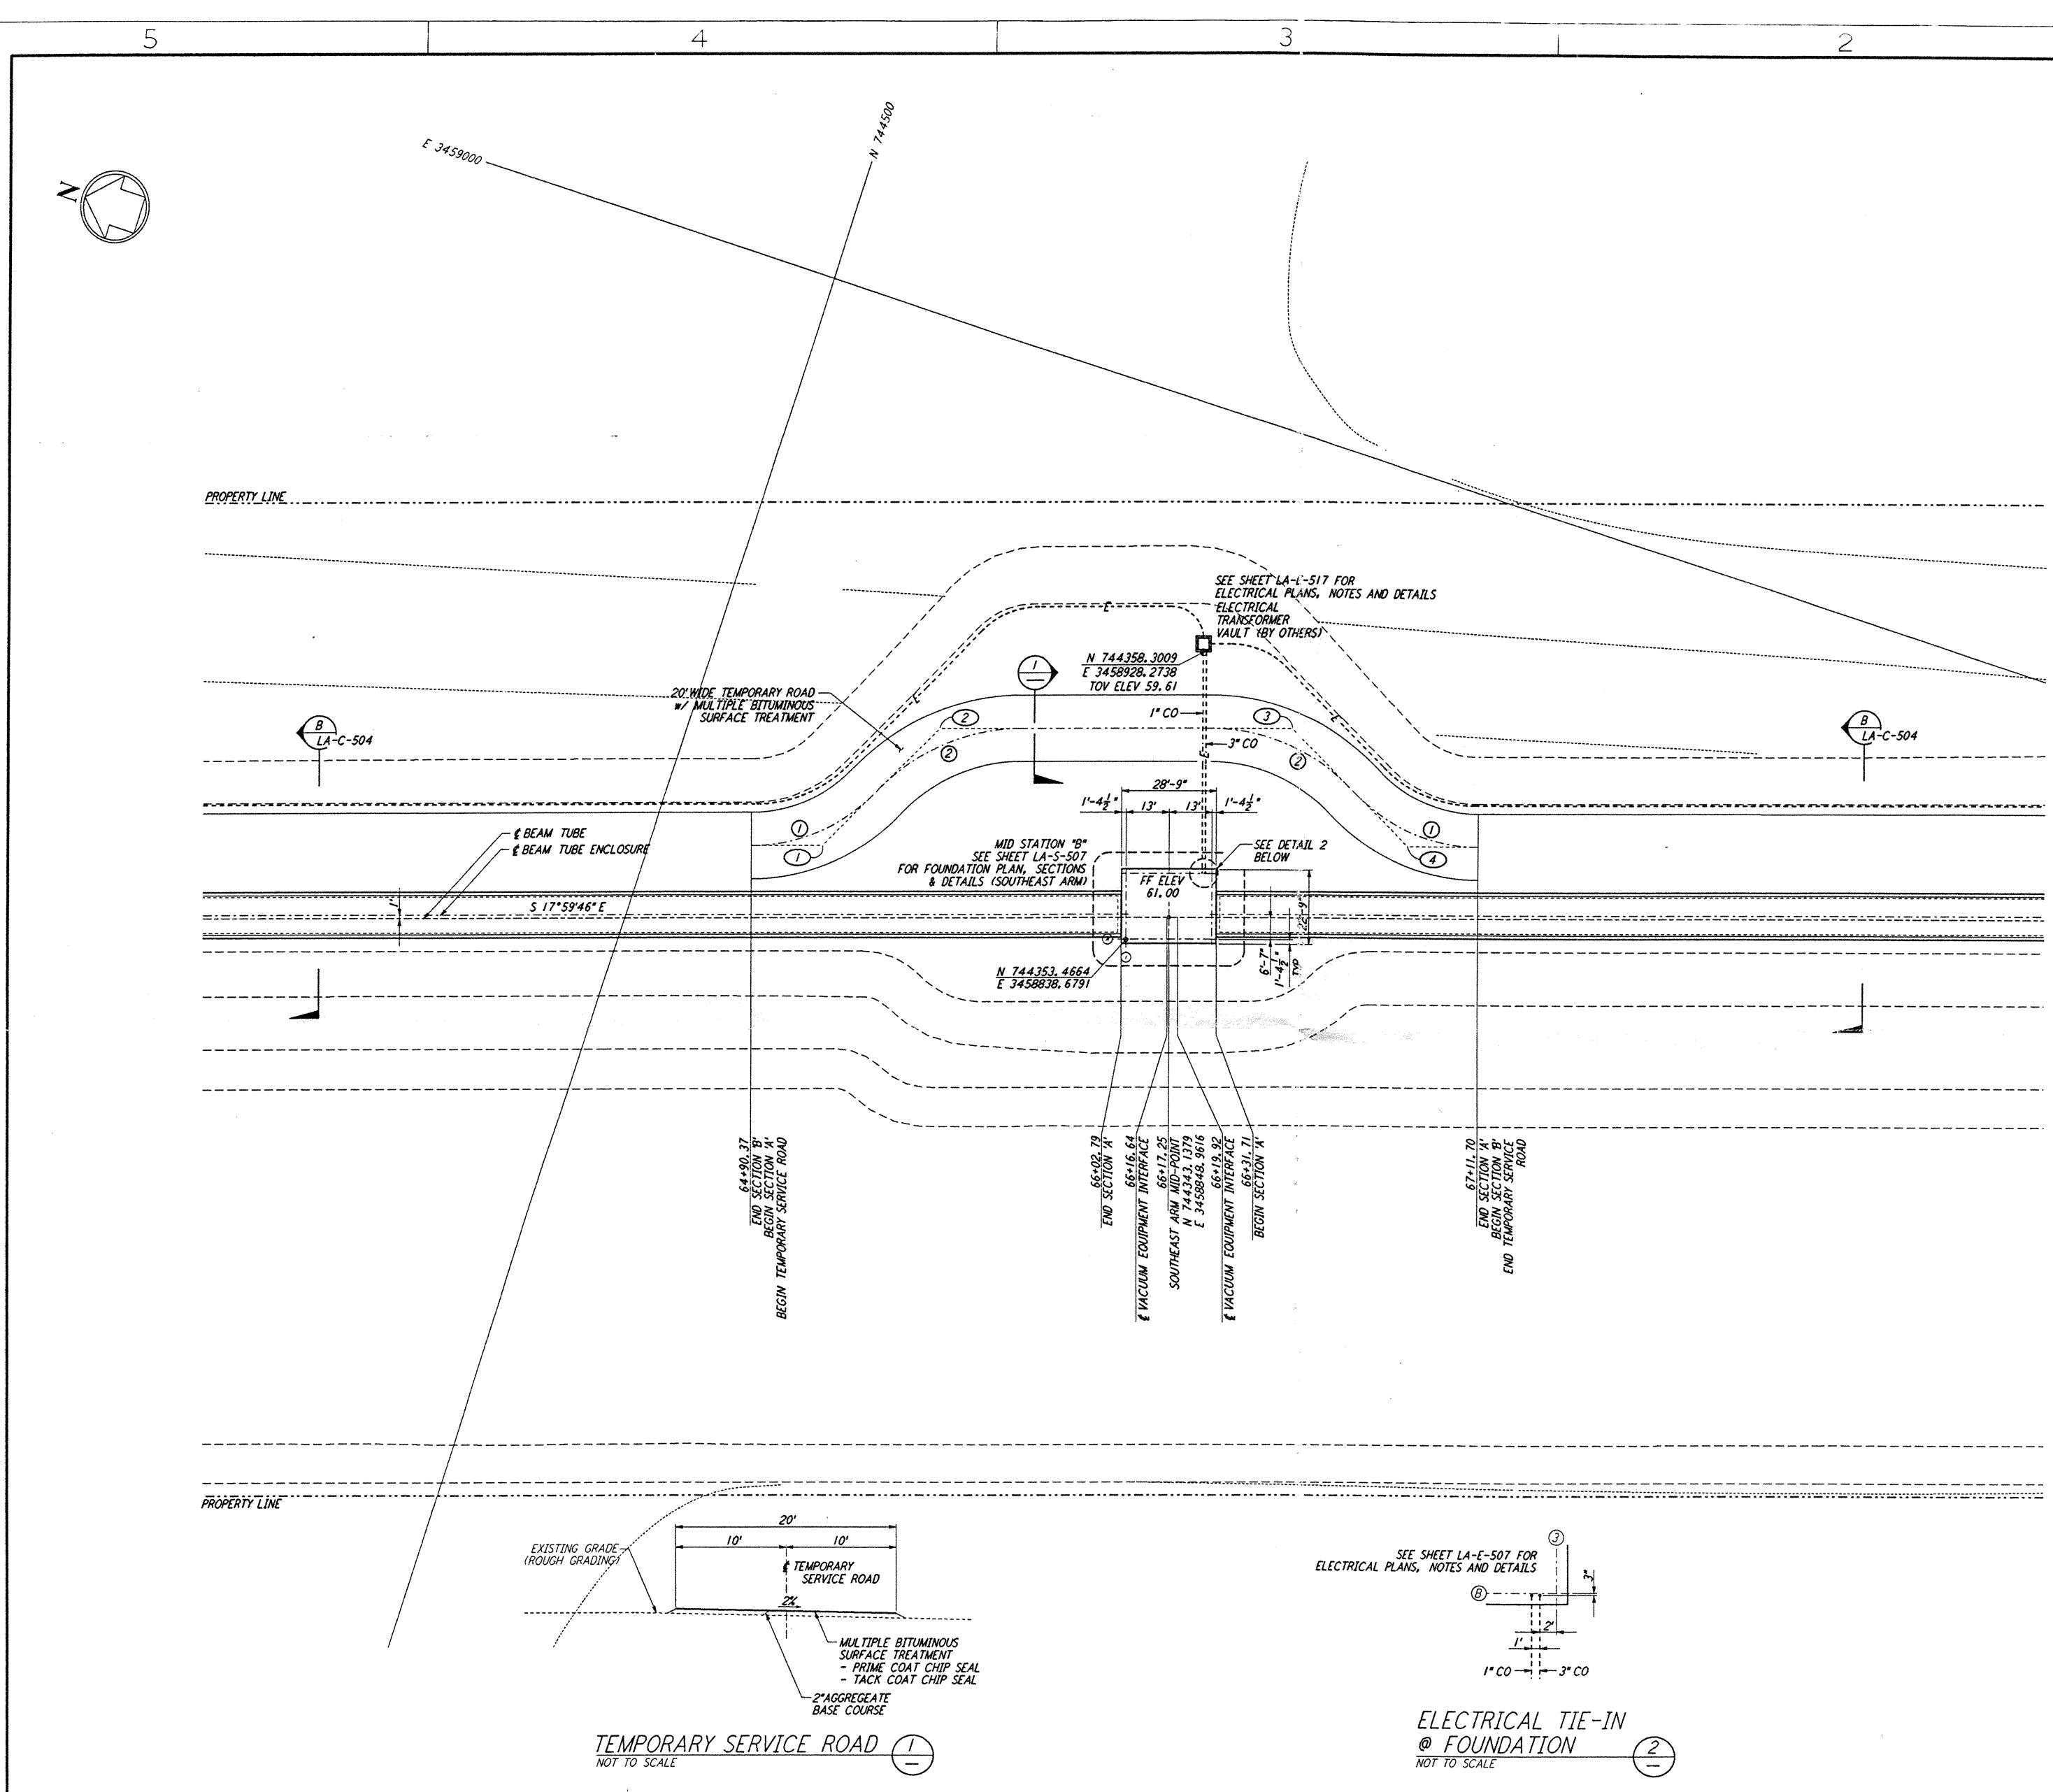


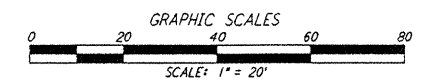
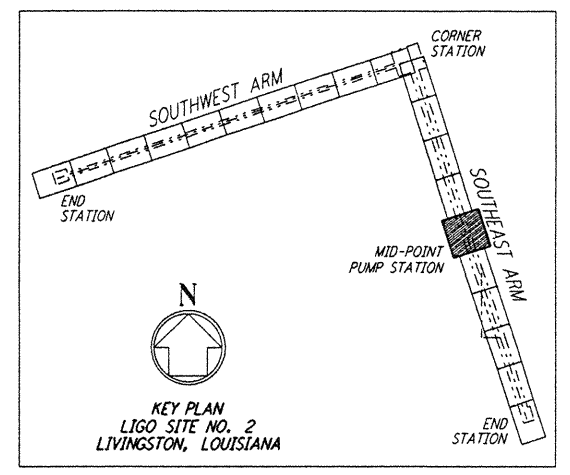
NOTES:
 1. SEE SHEET LA-C-502 FOR GENERAL NOTES, LEGEND AND ABBREVIATIONS.
 2. SEE SHEET LA-C-504 FOR TYPICAL SECTIONS AND DETAILS.

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| CURVE DATA | | | | | |
|-------------|--------|--------|---------|----------------|--|
| Δ | RADIUS | LENGTH | TANGENT | REMARK | |
| 1 45°00'00" | 52' | 40.84' | 21.54' | TEMPORARY ROAD | |
| 2 45°00'00" | 60' | 47.12' | 24.85' | TEMPORARY ROAD | |

| COORDINATES | | | |
|-------------|-------------|--------------|-------------------|
| Δ | NORTH | EAST | REMARK |
| 1 | 744450.1181 | 3458837.3414 | PI TEMPORARY ROAD |
| 2 | 744427.3479 | 3458882.0229 | PI TEMPORARY ROAD |
| 3 | 744325.2733 | 3458915.1812 | PI TEMPORARY ROAD |
| 4 | 744280.5922 | 3458892.4109 | PI TEMPORARY ROAD |



| NO. | DATE | BY | CHKD | ENGR | PROJ | DESCRIPTION |
|-----|---------|-----|------|------|------|---------------------|
| A | 6/28/96 | WRB | JML | CP | DM | FINAL DESIGN REVIEW |

| | | |
|----------|-----|---------|
| DRAWN | WRB | 6/24/96 |
| CHECKED | | |
| ENGINEER | | |
| PROJ | | |

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 CALIFORNIA INSTITUTE OF TECHNOLOGY
 MASSACHUSETTS INSTITUTE OF TECHNOLOGY

LASER INTERFEROMETER
 GRAVITATIONAL-WAVE OBSERVATORY
 BTE SITENWORK & FABRICATION - LIVINGSTON, LA

TITLE: CIVIL SOUTHEAST ARM PUMP STATION PLOT AND UTILITY PLAN
 SCALE: 1" = 20'
 SHEET NUMBER: LA-C-541
 CONTRACT NUMBER: PPI50969
 PROJECT NUMBER: 8094

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