


SOUTHWEST ARM (ARM 2)  
 MID STATION "A" - FOUNDATION PLAN

1/4" = 1'-0"

DATUM POINT EL 100'-0" = EL 63.00'

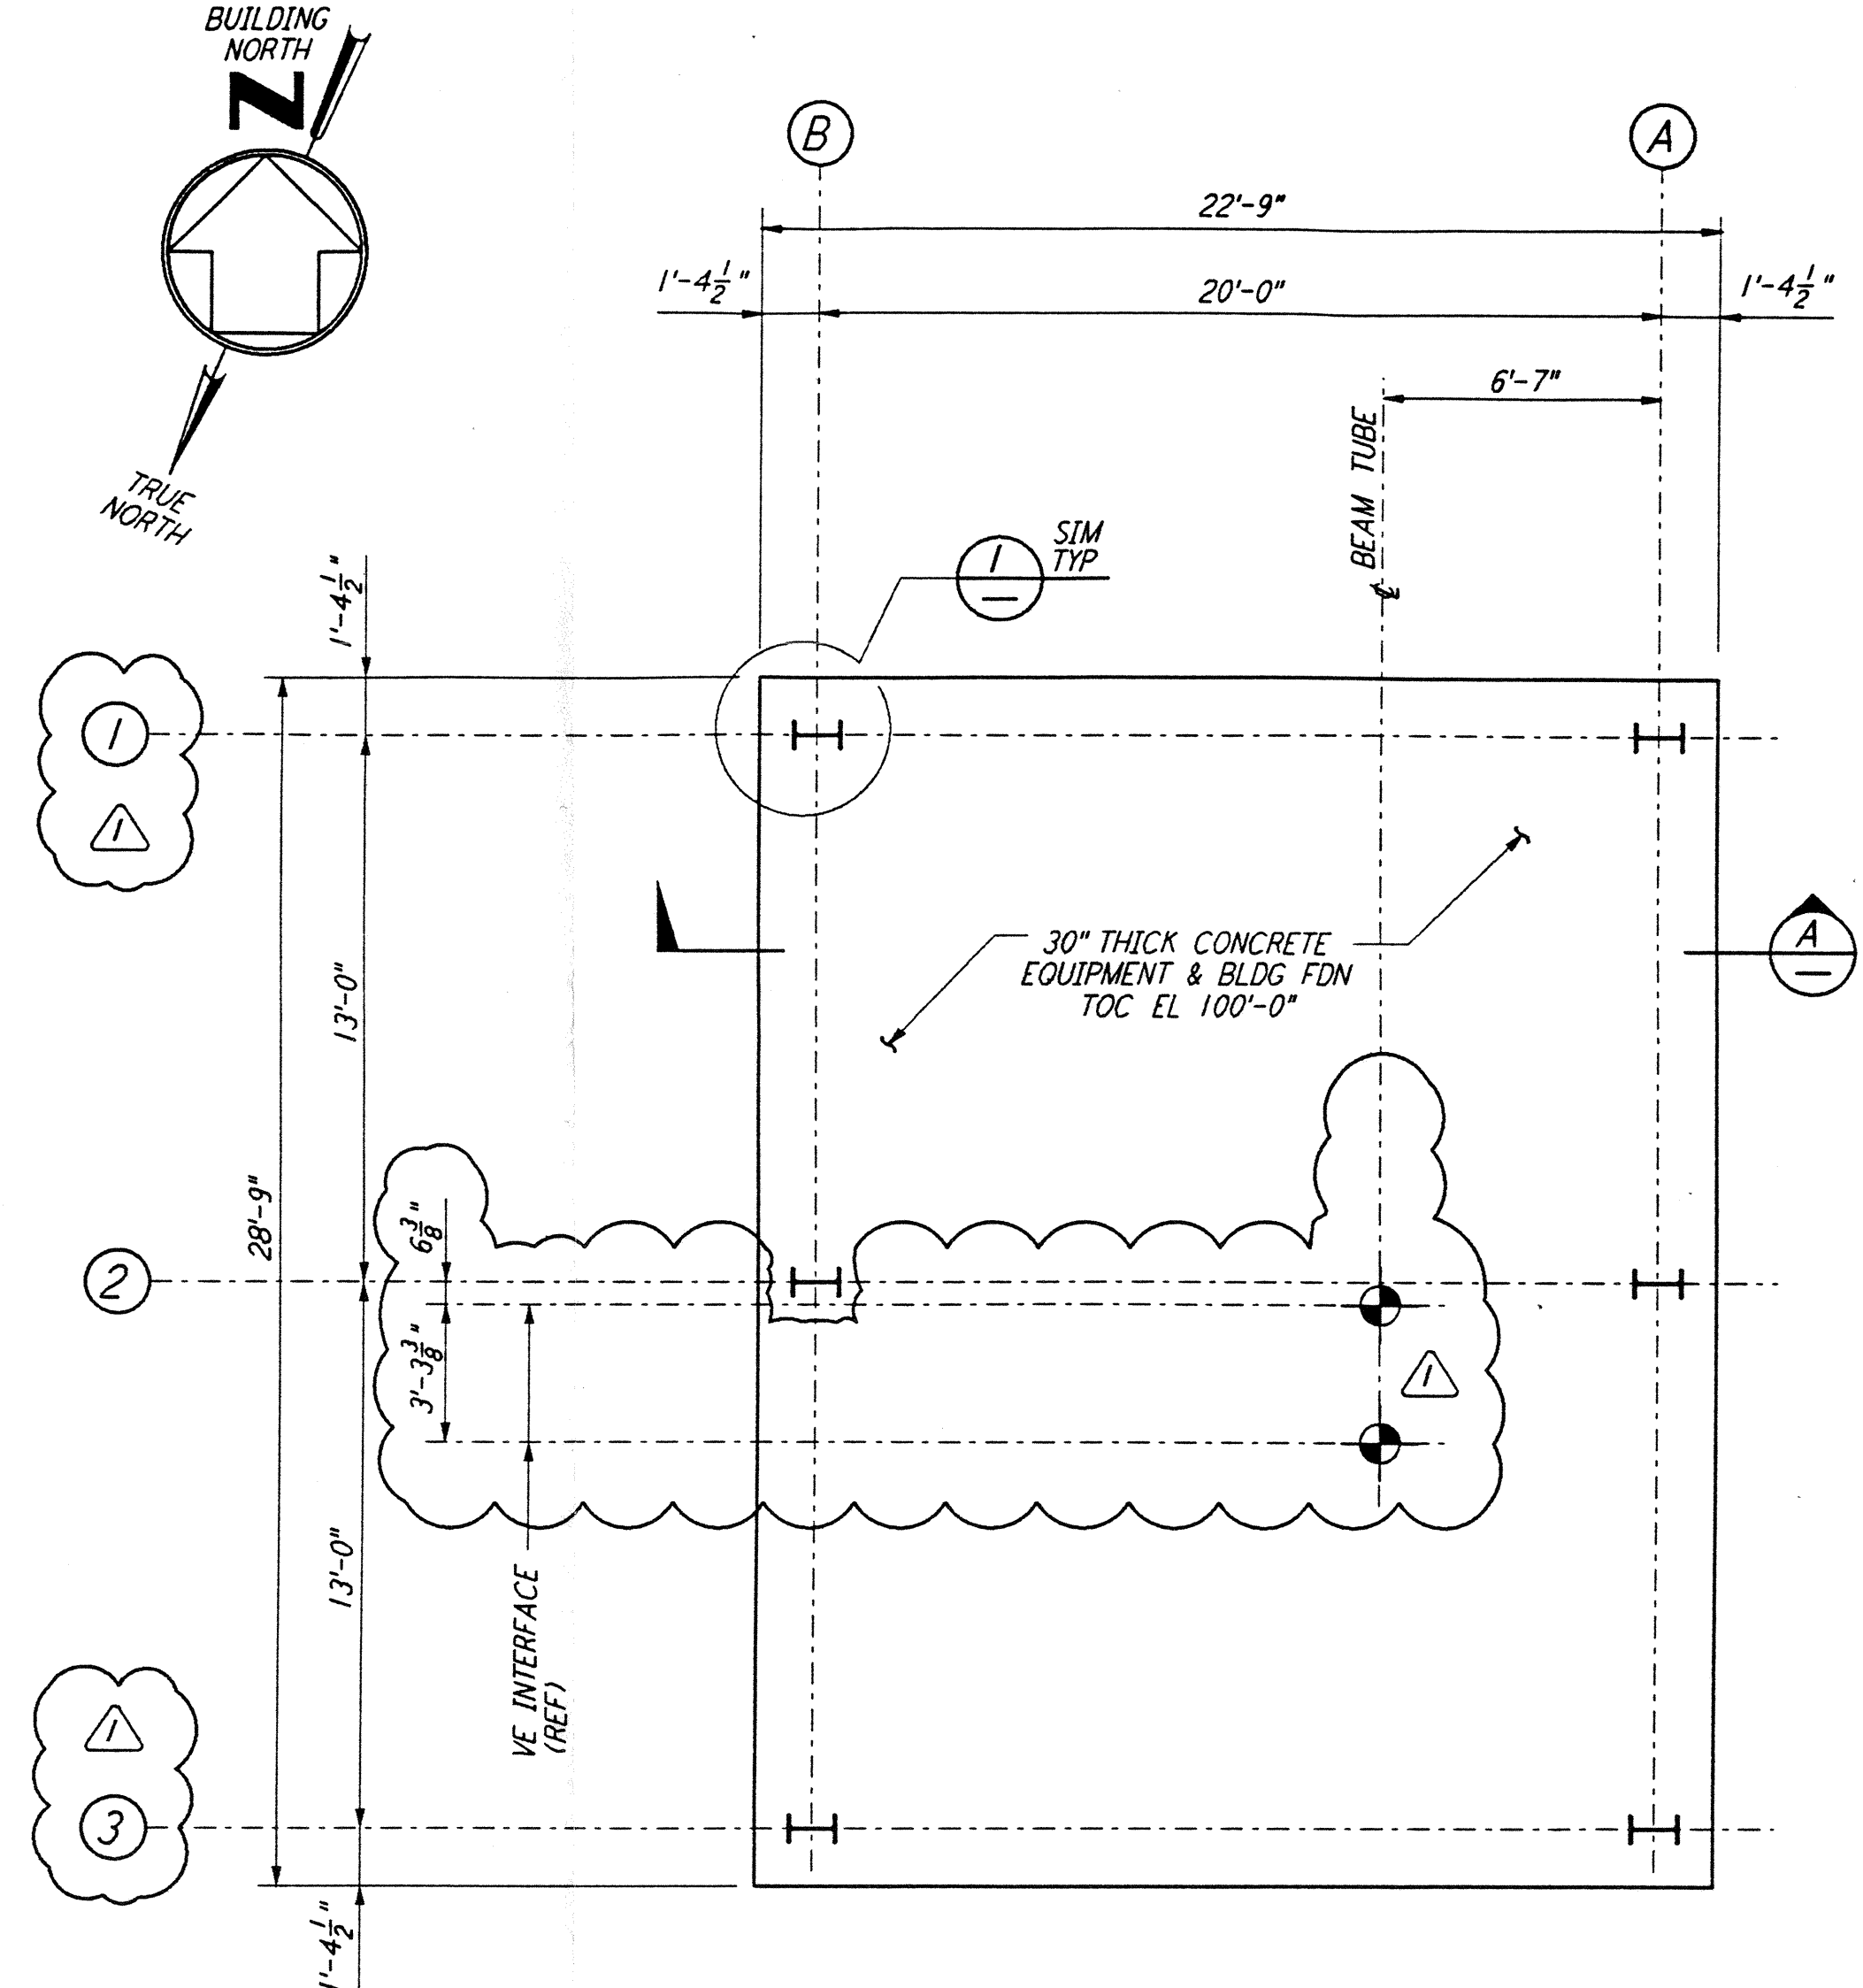


SOUTHEAST ARM (ARM 1)  
 MID STATION "B" - FOUNDATION PLAN

1/4" = 1'-0"


DATUM POINT EL 100'-0" = EL 61.00'

NOTES:

1. FOR GENERAL NOTES, ABBREVIATIONS AND SYMBOLS SEE DRAWING LA-S-501.

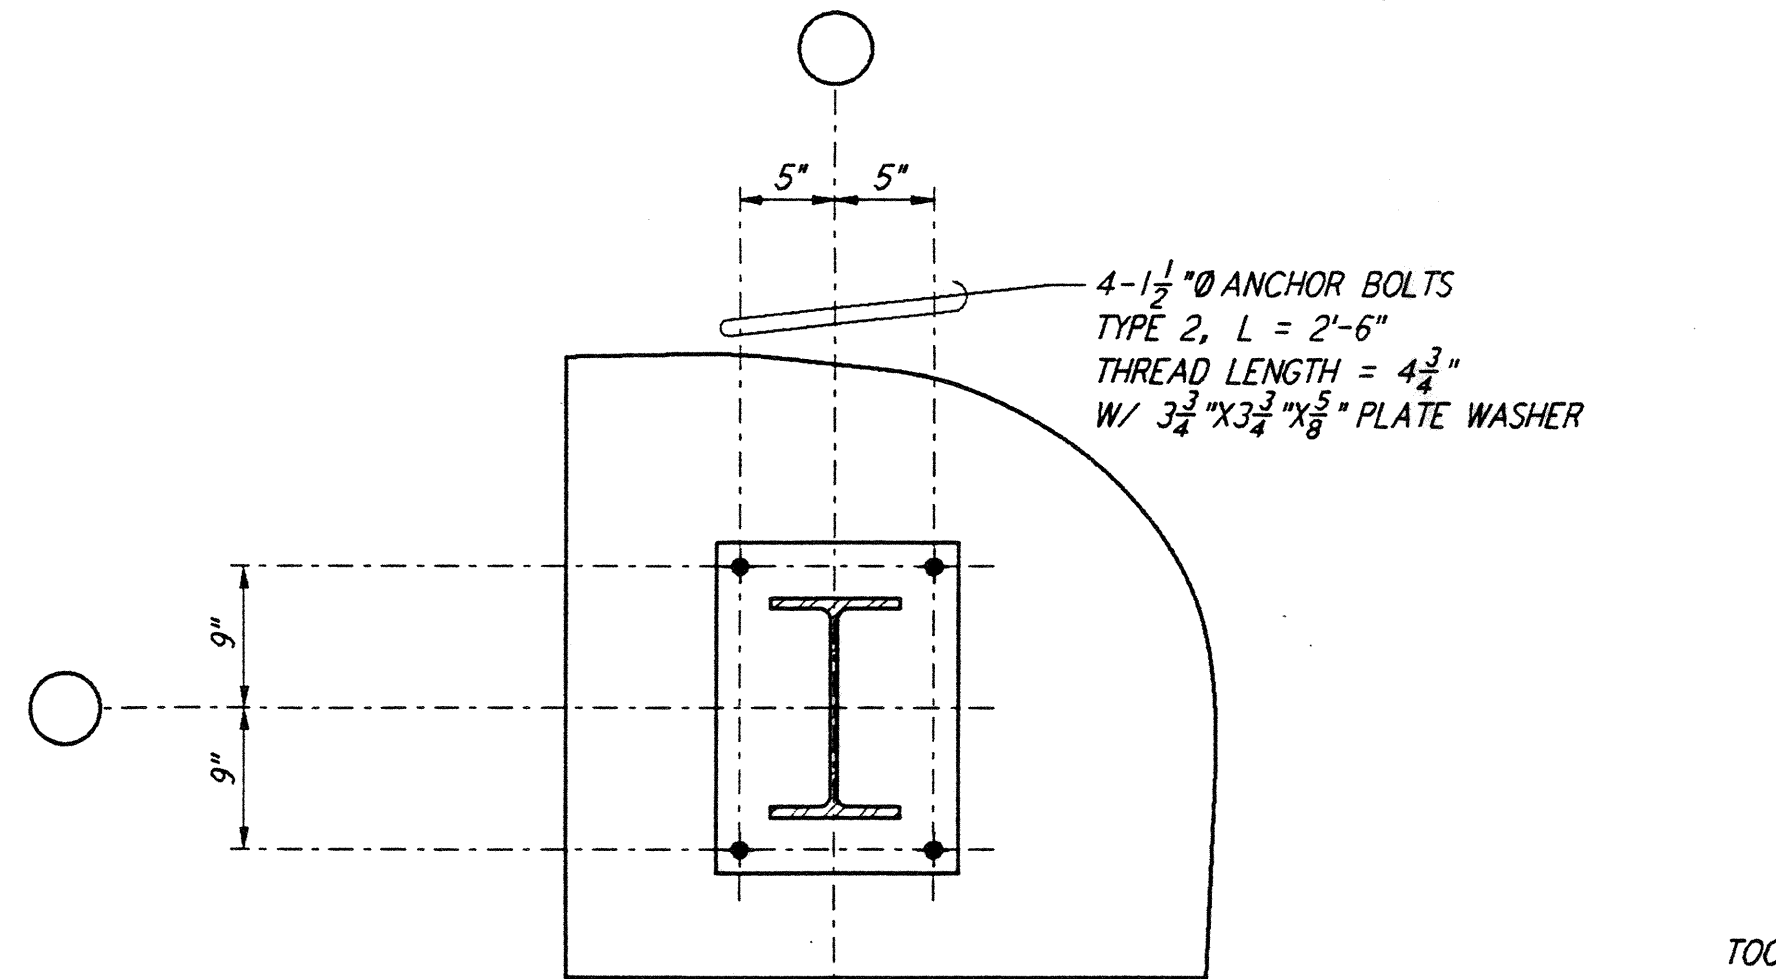


PLAN

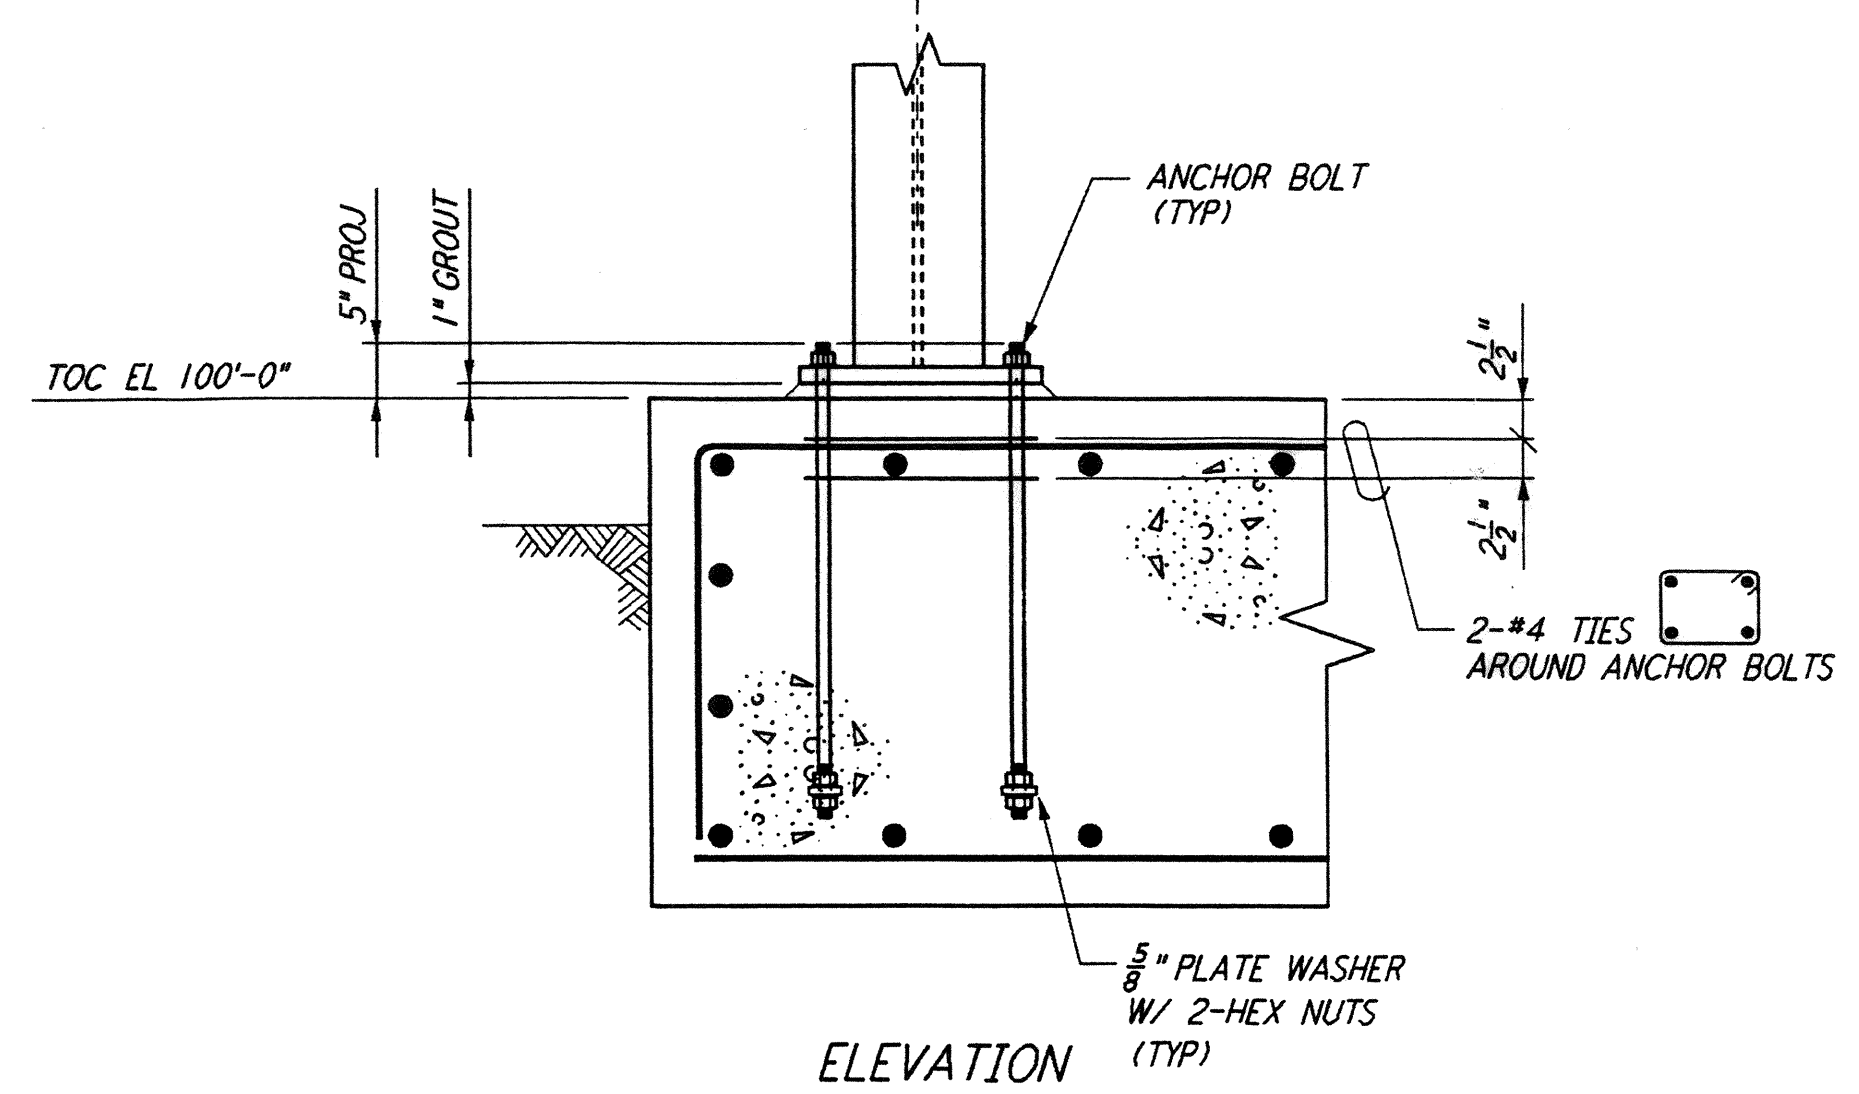


ELEVATION

DETAIL (1)  
 1" = 1'-0"

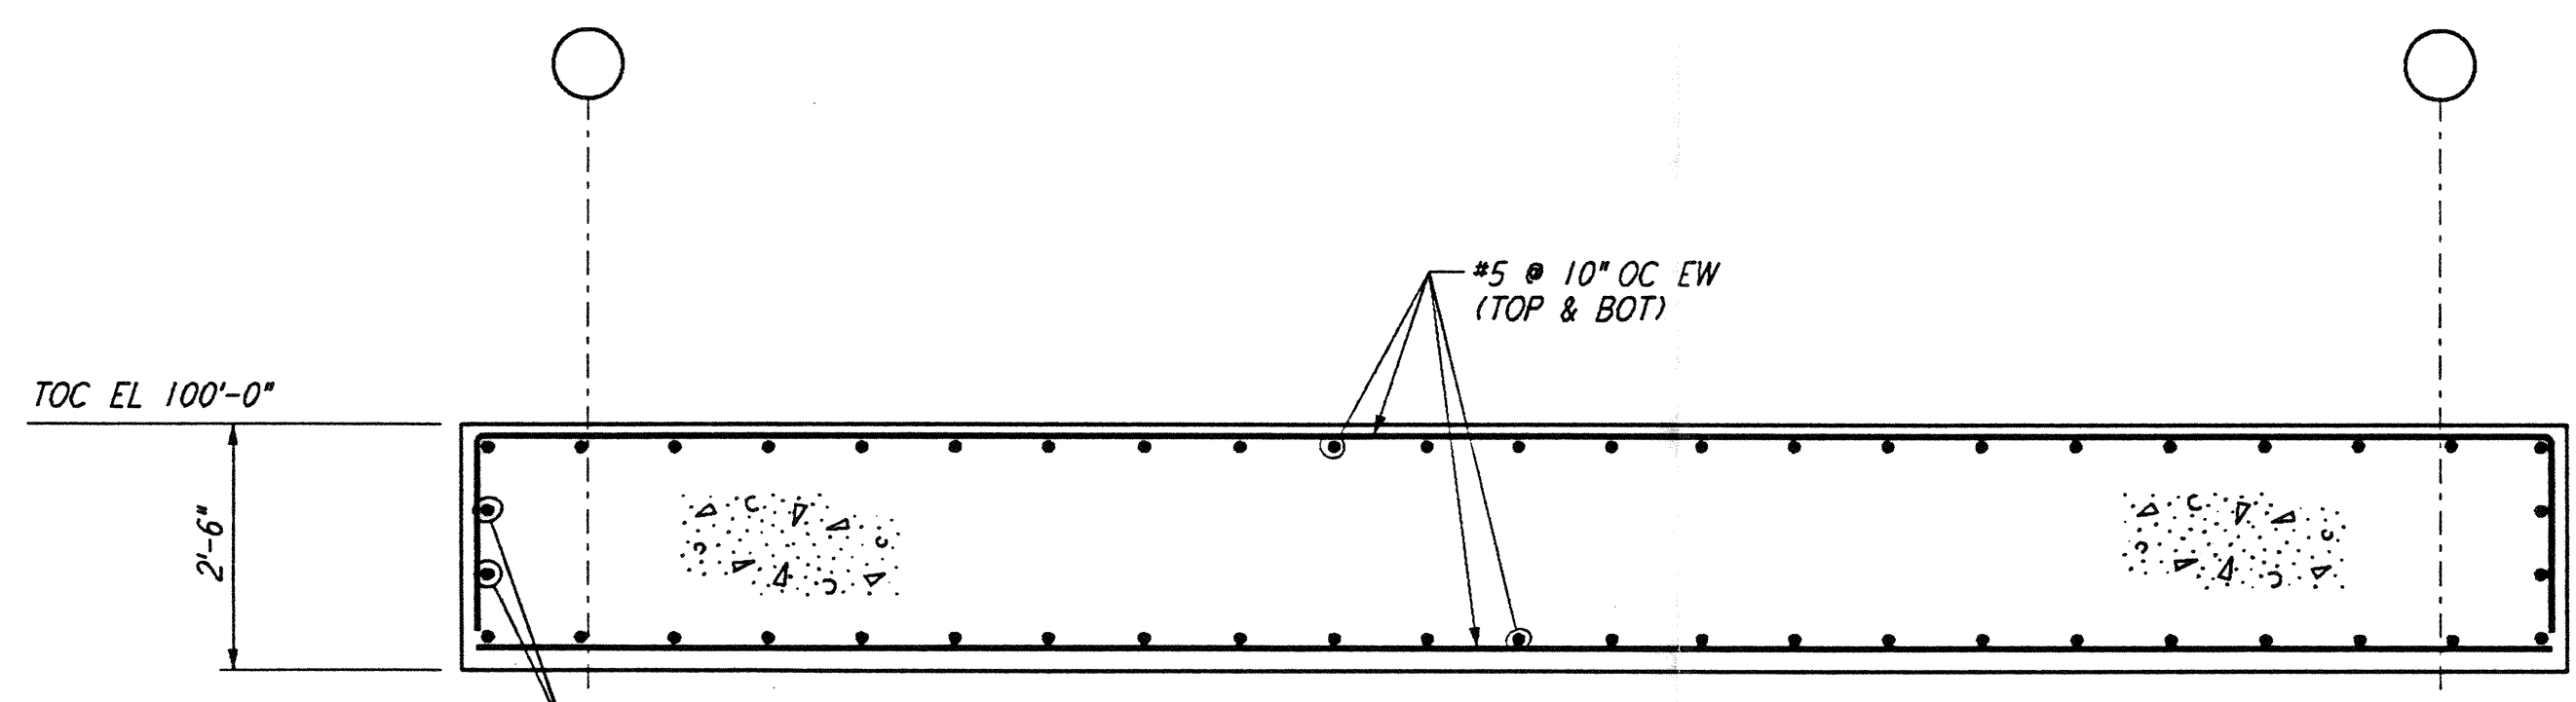


SECTION A

1/2" = 1'-0"

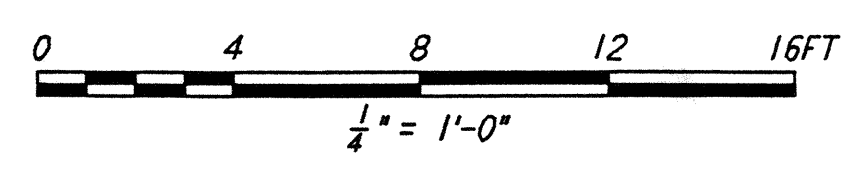

LIGO-D961242-01-0

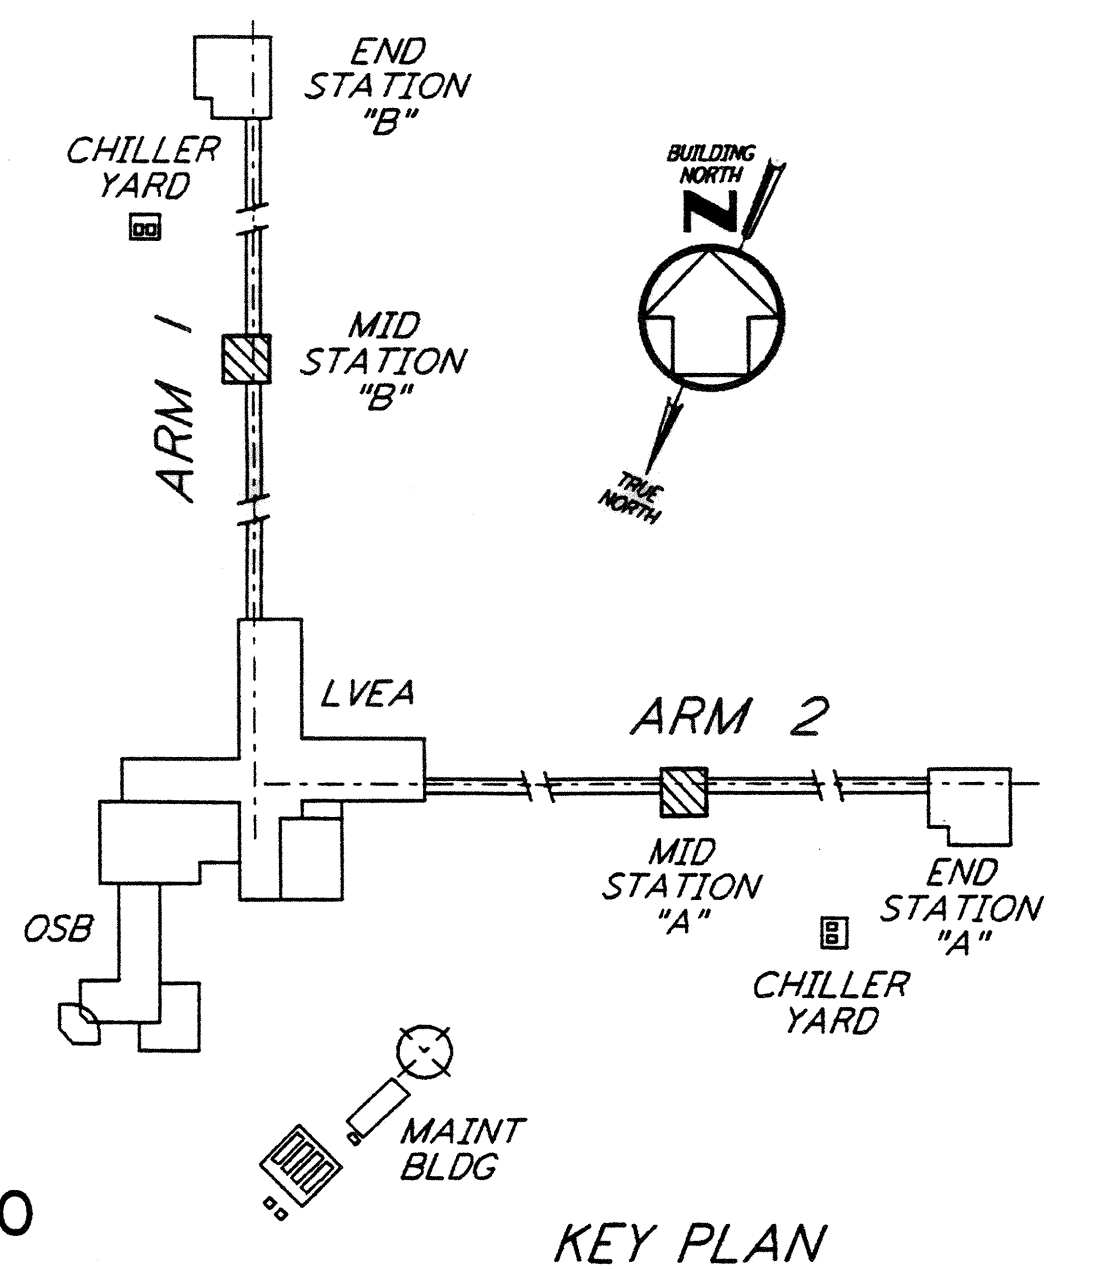


KEY PLAN

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NO.	DATE	BY	CHKD	ENGR	PROJ	DESCRIPTION
1	2-28-97	RM	GP			REV VE INTERFACE DIMS AT MID STA A&B

ISSUED FOR CONSTRUCTION		
DRAWN	MCS	11-15-96
CHECKED	DDM	11-15-96
ENGINEER	BP	11-15-96
PROJ	TDM	11-15-96

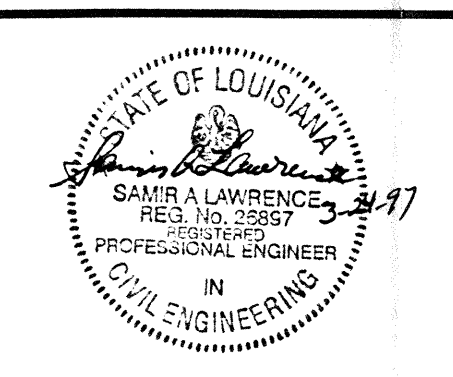

**PARSONS**

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 MASSACHUSETTS INSTITUTE OF TECHNOLOGY

LASER INTERFEROMETER  
 GRAVITATIONAL-WAVE OBSERVATORY  
 BEAM TUBE ENCLOSURE - LIVINGSTON, LA

TITLE: STRUCTURAL BEAM TUBE ENCLOSURE MID STATIONS "A" & "B" FOUNDATION PLANS

SCALE: AS NOTED

CONTRACT NUMBER: PPI50969

PROJECT NUMBER: 8094

SHEET NUMBER: LA-S-507