

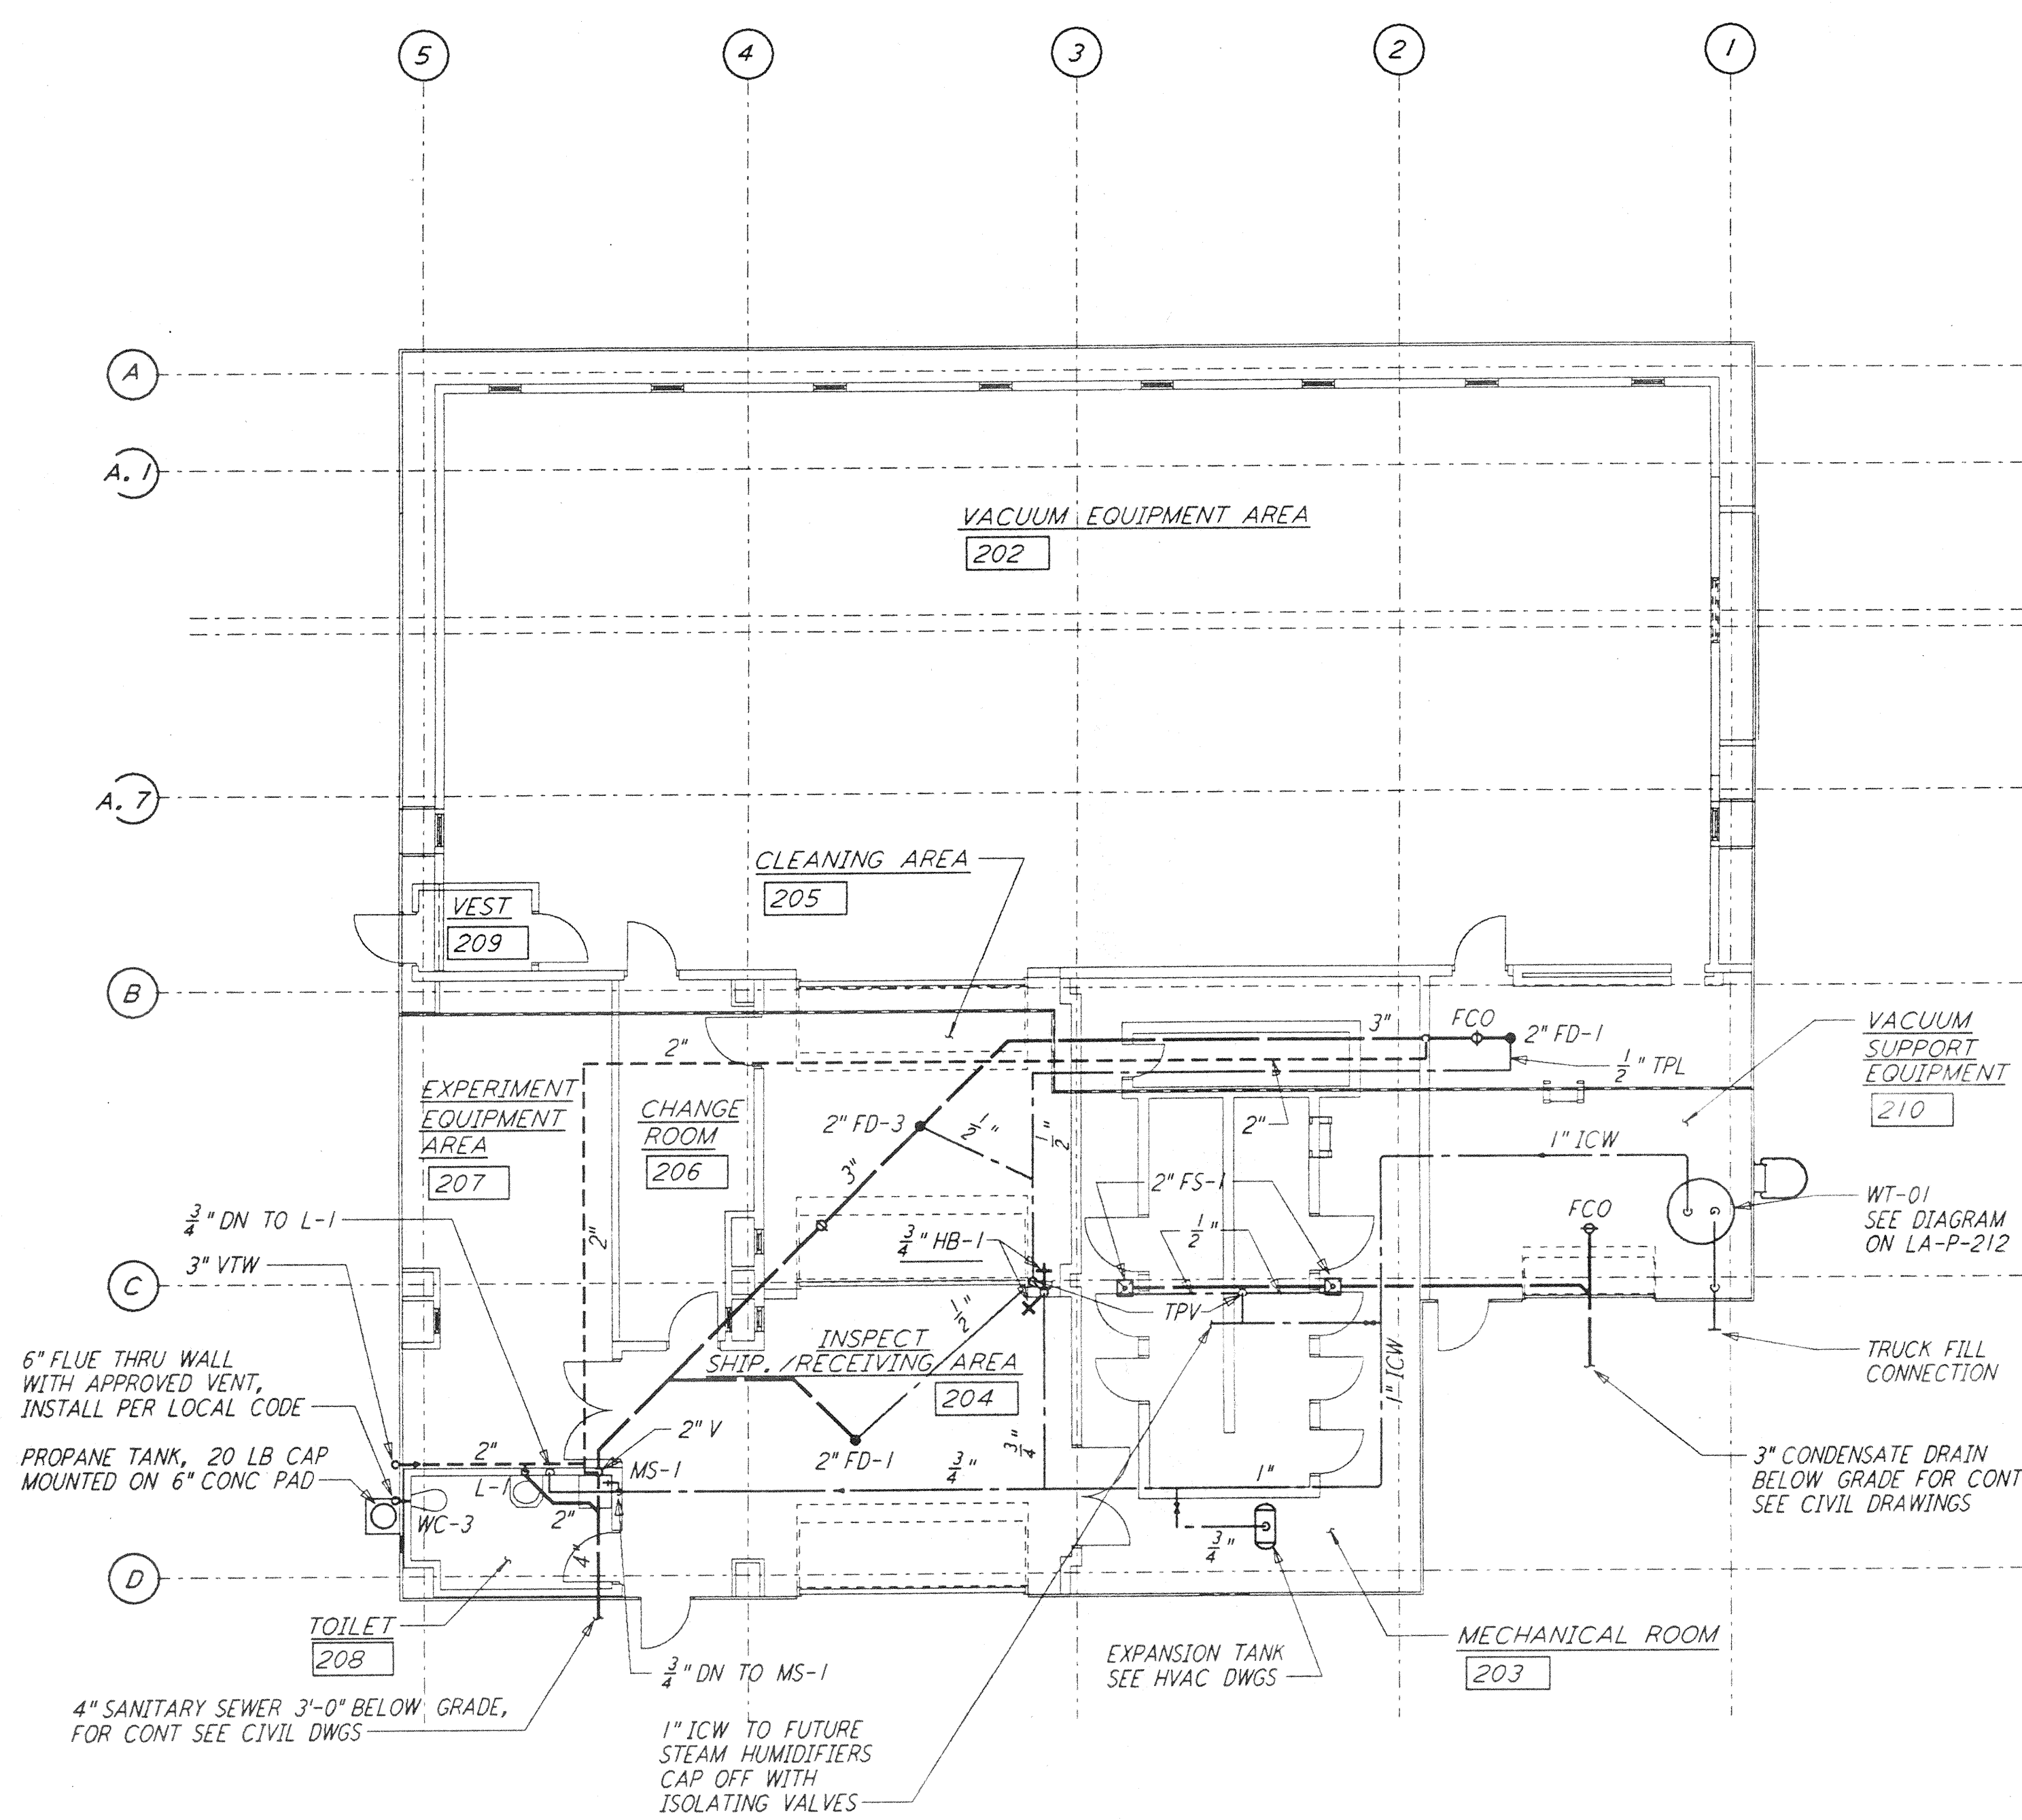
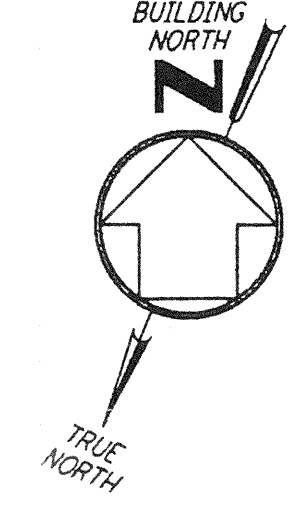



NOTE:
 1. PROVIDE SIGNS AT ALL WATER OUTLETS
 IN THE END STATIONS STATING:
 "DANGER - UNSAFE WATER"

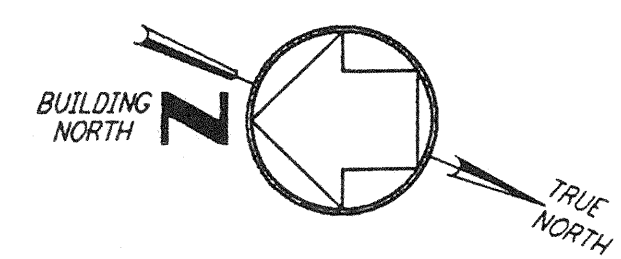

END STATION "B" FLOOR PLAN
 $\frac{1}{8}'' = 1'-0''$

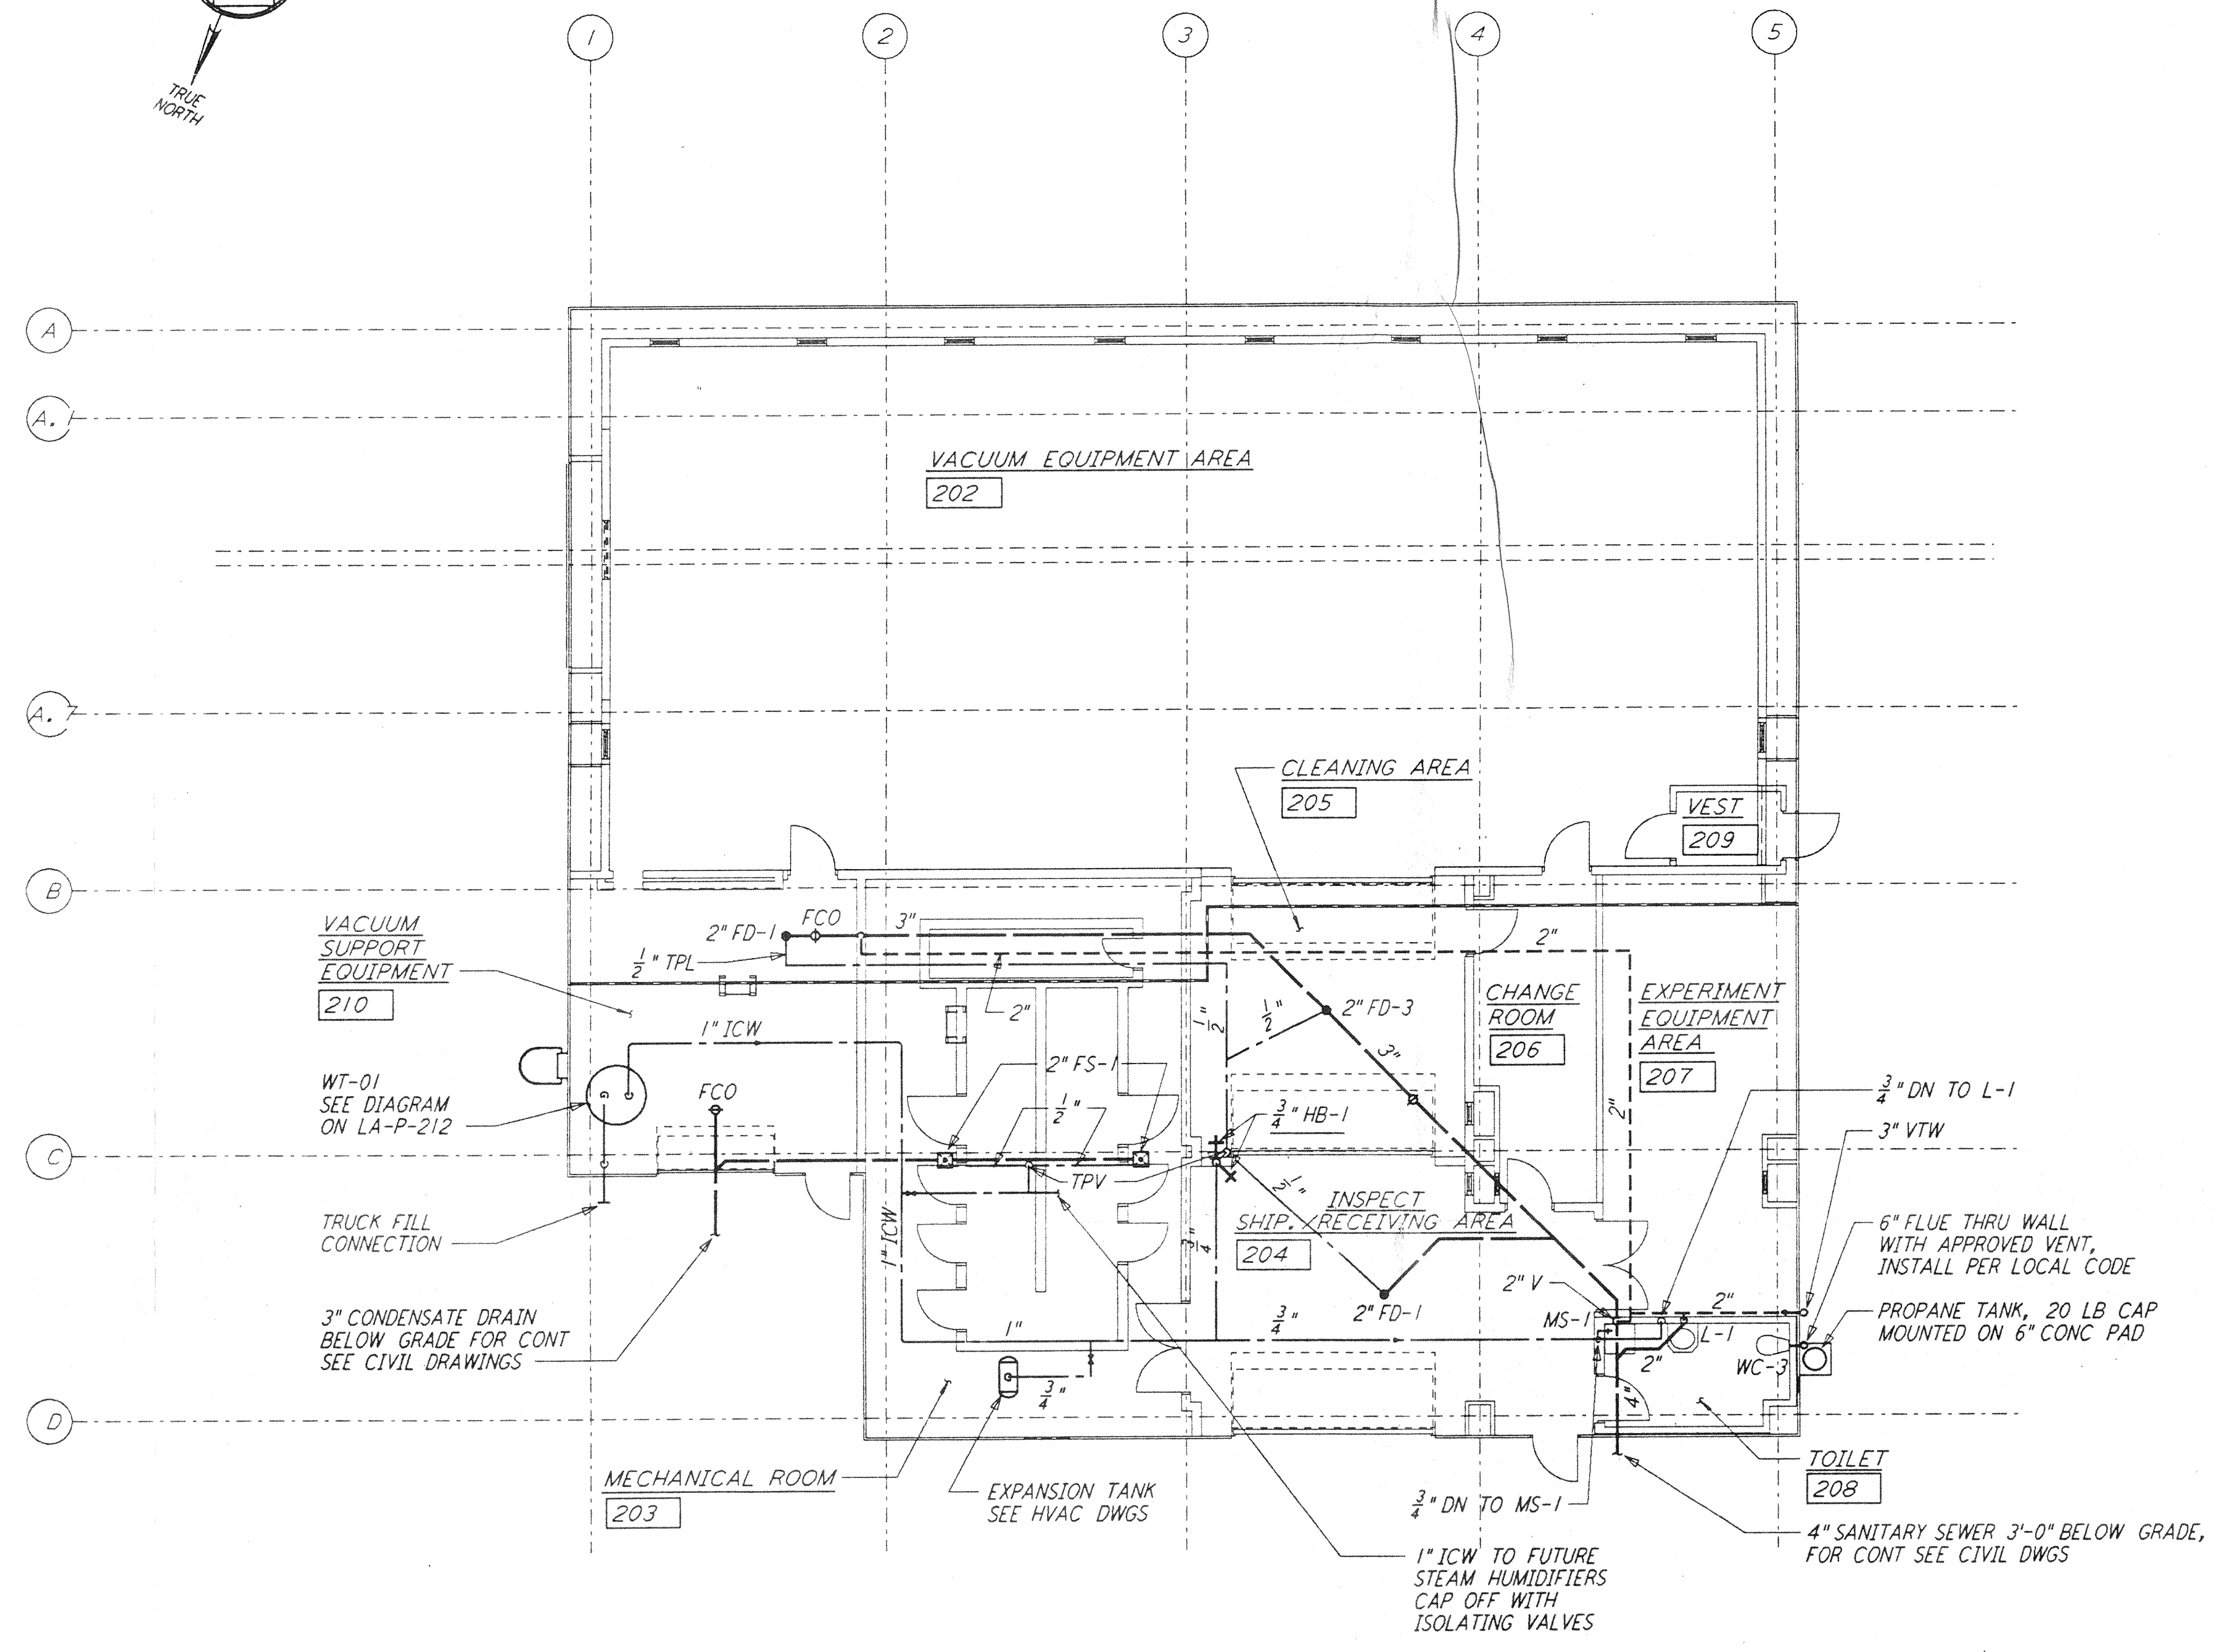

END STATION "A" FLOOR PLAN
 $\frac{1}{8}'' = 1'-0''$

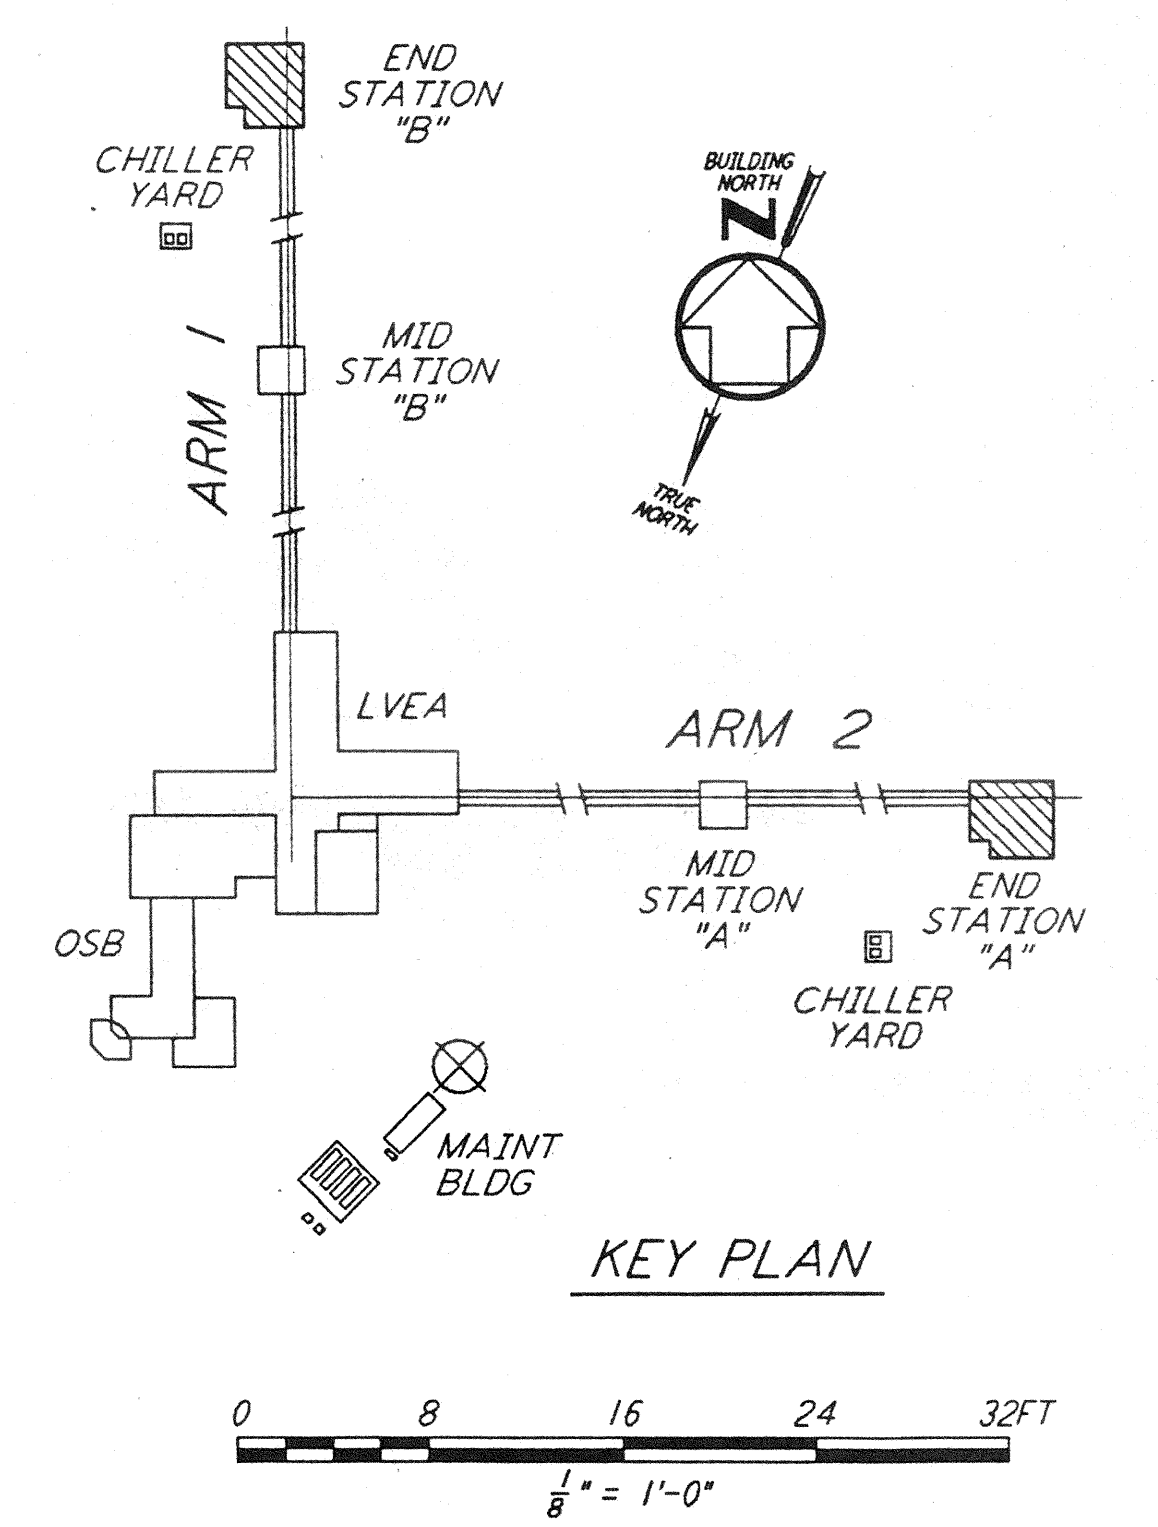


KEY PLAN

0 8 16 24 32FT
 $\frac{1}{8}'' = 1'-0''$

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ISSUED FOR CONSTRUCTION	
DRAWN	DG 11-15-96
CHECKED	ME 10-25-96
ENGINEER	AA 10-23-96
PROJ	207B 11/15/96

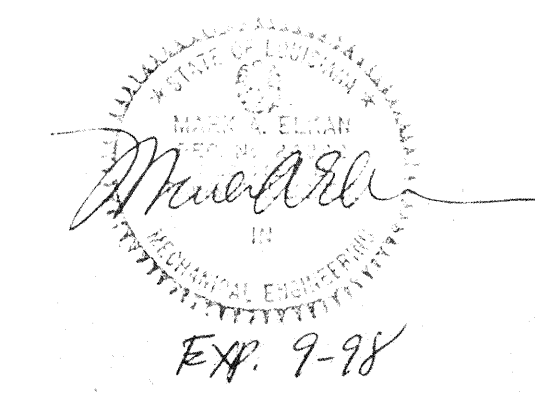

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 MASSACHUSETTS INSTITUTE OF TECHNOLOGY

LASER INTERFEROMETER
 GRAVITATIONAL-WAVE OBSERVATORY
 SITE NO. 2 - LIVINGSTON, LOUISIANA

**PLUMBING
 END STATION
 FLOOR PLAN**

SCALE: AS NOTED
 CONTRACT NUMBER: PPI50969
 PROJECT NUMBER: 8094

SHEET NUMBER: **LA-P-211**

NO.	DATE	BY	CHKD	ENGR	PROJ	DESCRIPTION