


5


4

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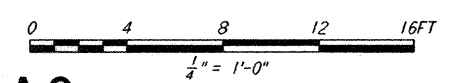
2

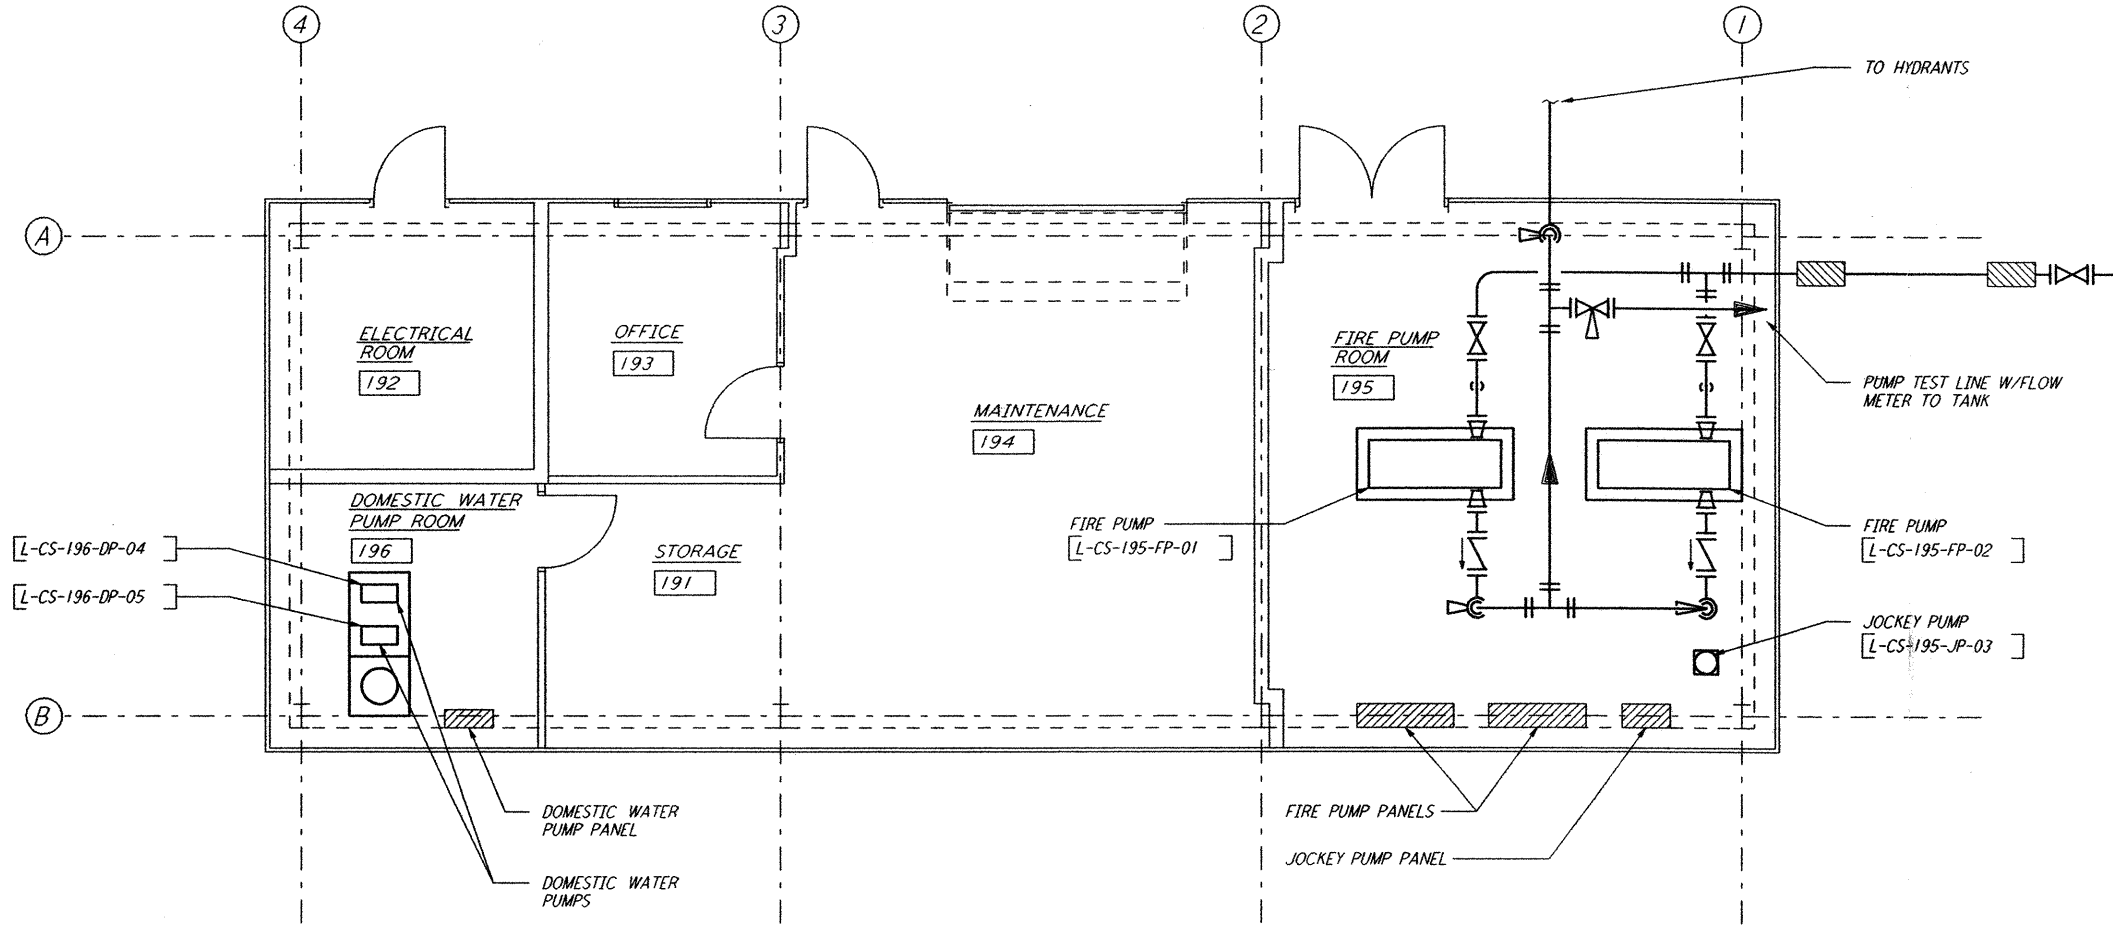

FIRE PUMP ROOM FLOOR PLAN
 $\frac{1}{4}'' = 1'-0''$

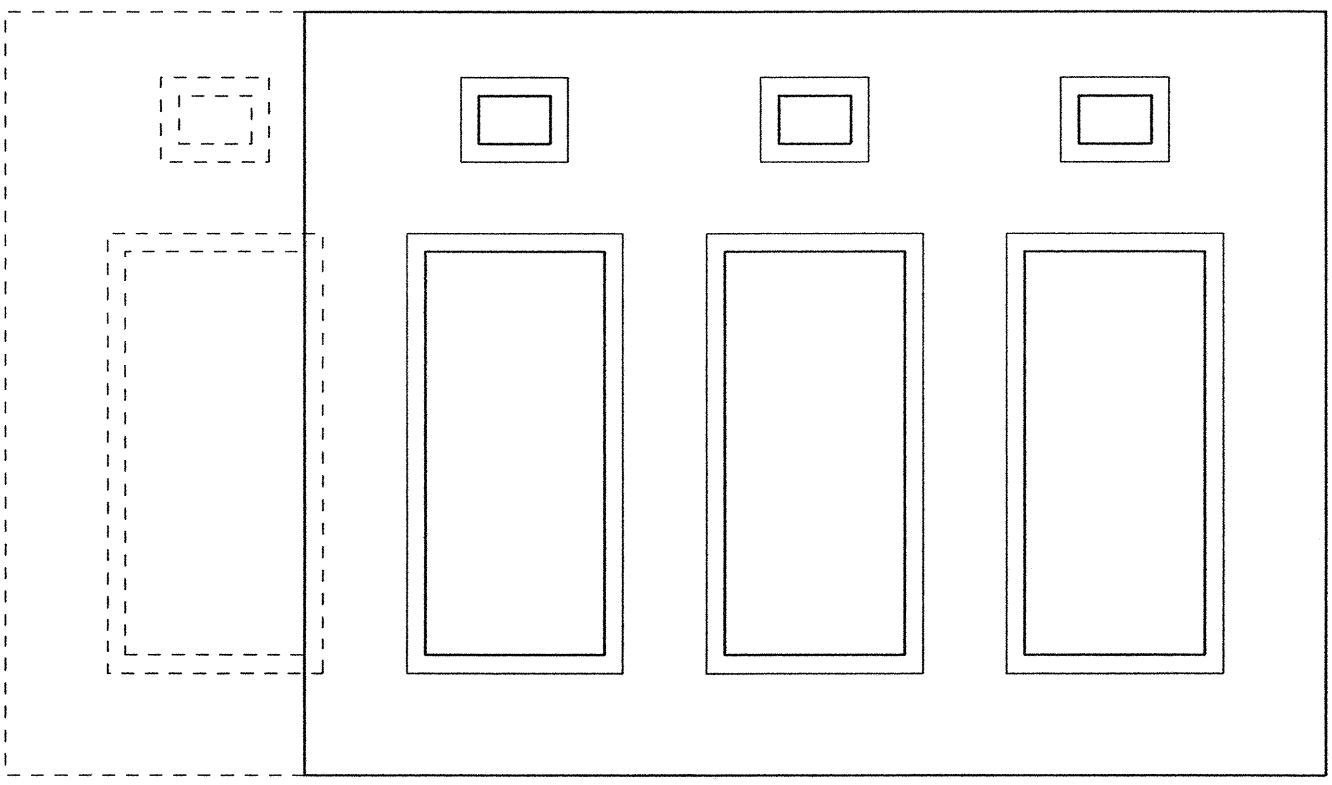

CHILLER YARD PLAN
 $\frac{1}{4}'' = 1'-0''$



LIGO-D961050-A-0

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LASER INTERFEROMETER
 GRAVITATIONAL-WAVE OBSERVATORY
 SITE NO. 2 - LIVINGSTON, LOUISIANA

TITLE: CORNER STATION
 CHILLER YARD AND
 FIRE PUMP ROOM
 FLOOR PLAN

SCALE: AS NOTED
 CONTRACT NUMBER: PP150969
 PROJECT NUMBER: 8094

SHEET NUMBER: **LA-P-113**

Mon Oct 30 20:56:29 1995 s3-v18b2 J:\PLOTS\QUEUES\18B2\MU113E.PRF