

LEGEND:

- ⊕ RECEPTACLE, 20BY, 3Ø, 5W, 4 POLE GROUNDING
 NEMA L21-30R HUBBELL #2810 WITH WEATHERPROOF BOX AND COVER
- ⊕ RECEPTACLE, 20BY, 3Ø, 5W, 4 POLE GROUNDING
 NEMA L21-30R HUBBELL #2810 WITH BOX AND COVER

NOTES:


1. FOR ABBREVIATIONS AND ACRONYMS SEE DWG. LA-E-001.
2. FOR SYMBOLS SEE DWG. LA-E-002.
3. FOR GENERAL NOTES SEE DWG. LA-E-100.
4. PANELS L-CS-175-RP-01 AND L-CS-175-RP-02 ARE RESERVED FOR CUSTOMER USE.
5. CIRCUIT SHOWN FEEDING THIS ITEM IS FROM PANEL W-CS-107-HP-02. FOR LOCATION SEE DWG. LA-E-100.
6. FOR ALL PANEL FEEDER CONDUIT AND CABLE SIZES SEE SINGLE LINE DIAGRAM DWG. LA-E-006. ROUTE CABLES IN CONCEALED CONDUIT TO L-CS-107-SB-01. FOR LOCATION SEE DWG. LA-E-100.
7. SEE PANEL SCHEDULES ON DWG. LA-E-115 & LA-E-116 FOR GFCI CIRCUITS.

REFERENCE DRAWINGS:


- LA-E-109 COMMUNICATION RISER DIAGRAM
- LA-E-115 LIGHTING AND POWER PANEL SCHEDULES
- LA-E-116 LIGHTING AND POWER PANEL SCHEDULES

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RECEPTACLE/POWER PANEL NUMBER IDENTIFICATION SCHEDULE (SEE NOTE 7)					
ROOM NUMBER	PANEL NUMBER FOR DUPLEX RECEPTACLE	PANEL NUMBER FOR DUAL-DUPLEX RECEPTACLE	PANEL NUMBER FOR 3Ø, 5-POLE FOR JUNCTION BOX POWER	PANEL NUMBER FOR ROLL-UP DOOR POWER	
160	L-CS-163-RP-01	---	---	L-CS-163-RP-01	---
161	L-CS-163-RP-01	L-CS-163-RP-02	---	L-CS-163-RP-01	---
162	L-CS-163-RP-01	L-CS-163-RP-02	---	L-CS-163-RP-01	---
163	L-CS-163-RP-01	L-CS-163-RP-02	---	L-CS-163-RP-01	---
164	---	---	---	---	---
165	L-CS-163-RP-01	L-CS-163-RP-02	L-CS-163-RP-01	---	---
166	L-CS-168-RP-01	---	---	L-CS-172-PP-01	---
167	L-CS-168-RP-01	---	L-CS-172-RP-01	L-CS-172-PP-01	---
168	L-CS-168-RP-01	---	---	---	---
169	L-CS-168-RP-01	---	L-CS-168-RP-01	L-CS-172-PP-01	---
170	L-CS-172-RP-01	---	---	L-CS-172-PP-01	---
171	L-CS-172-RP-01	---	---	---	---
172	L-CS-172-RP-01	---	---	---	---
173	L-CS-172-RP-01	---	---	L-CS-172-PP-01	---
174	L-CS-172-RP-01	---	L-CS-172-RP-01	L-CS-172-PP-01	---
175	L-CS-172-RP-01	---	L-CS-172-RP-01	---	---
176	---	---	---	---	---
177	L-CS-163-RP-01	---	---	---	---
178	---	---	---	---	---
179	L-CS-163-RP-01	---	---	---	---

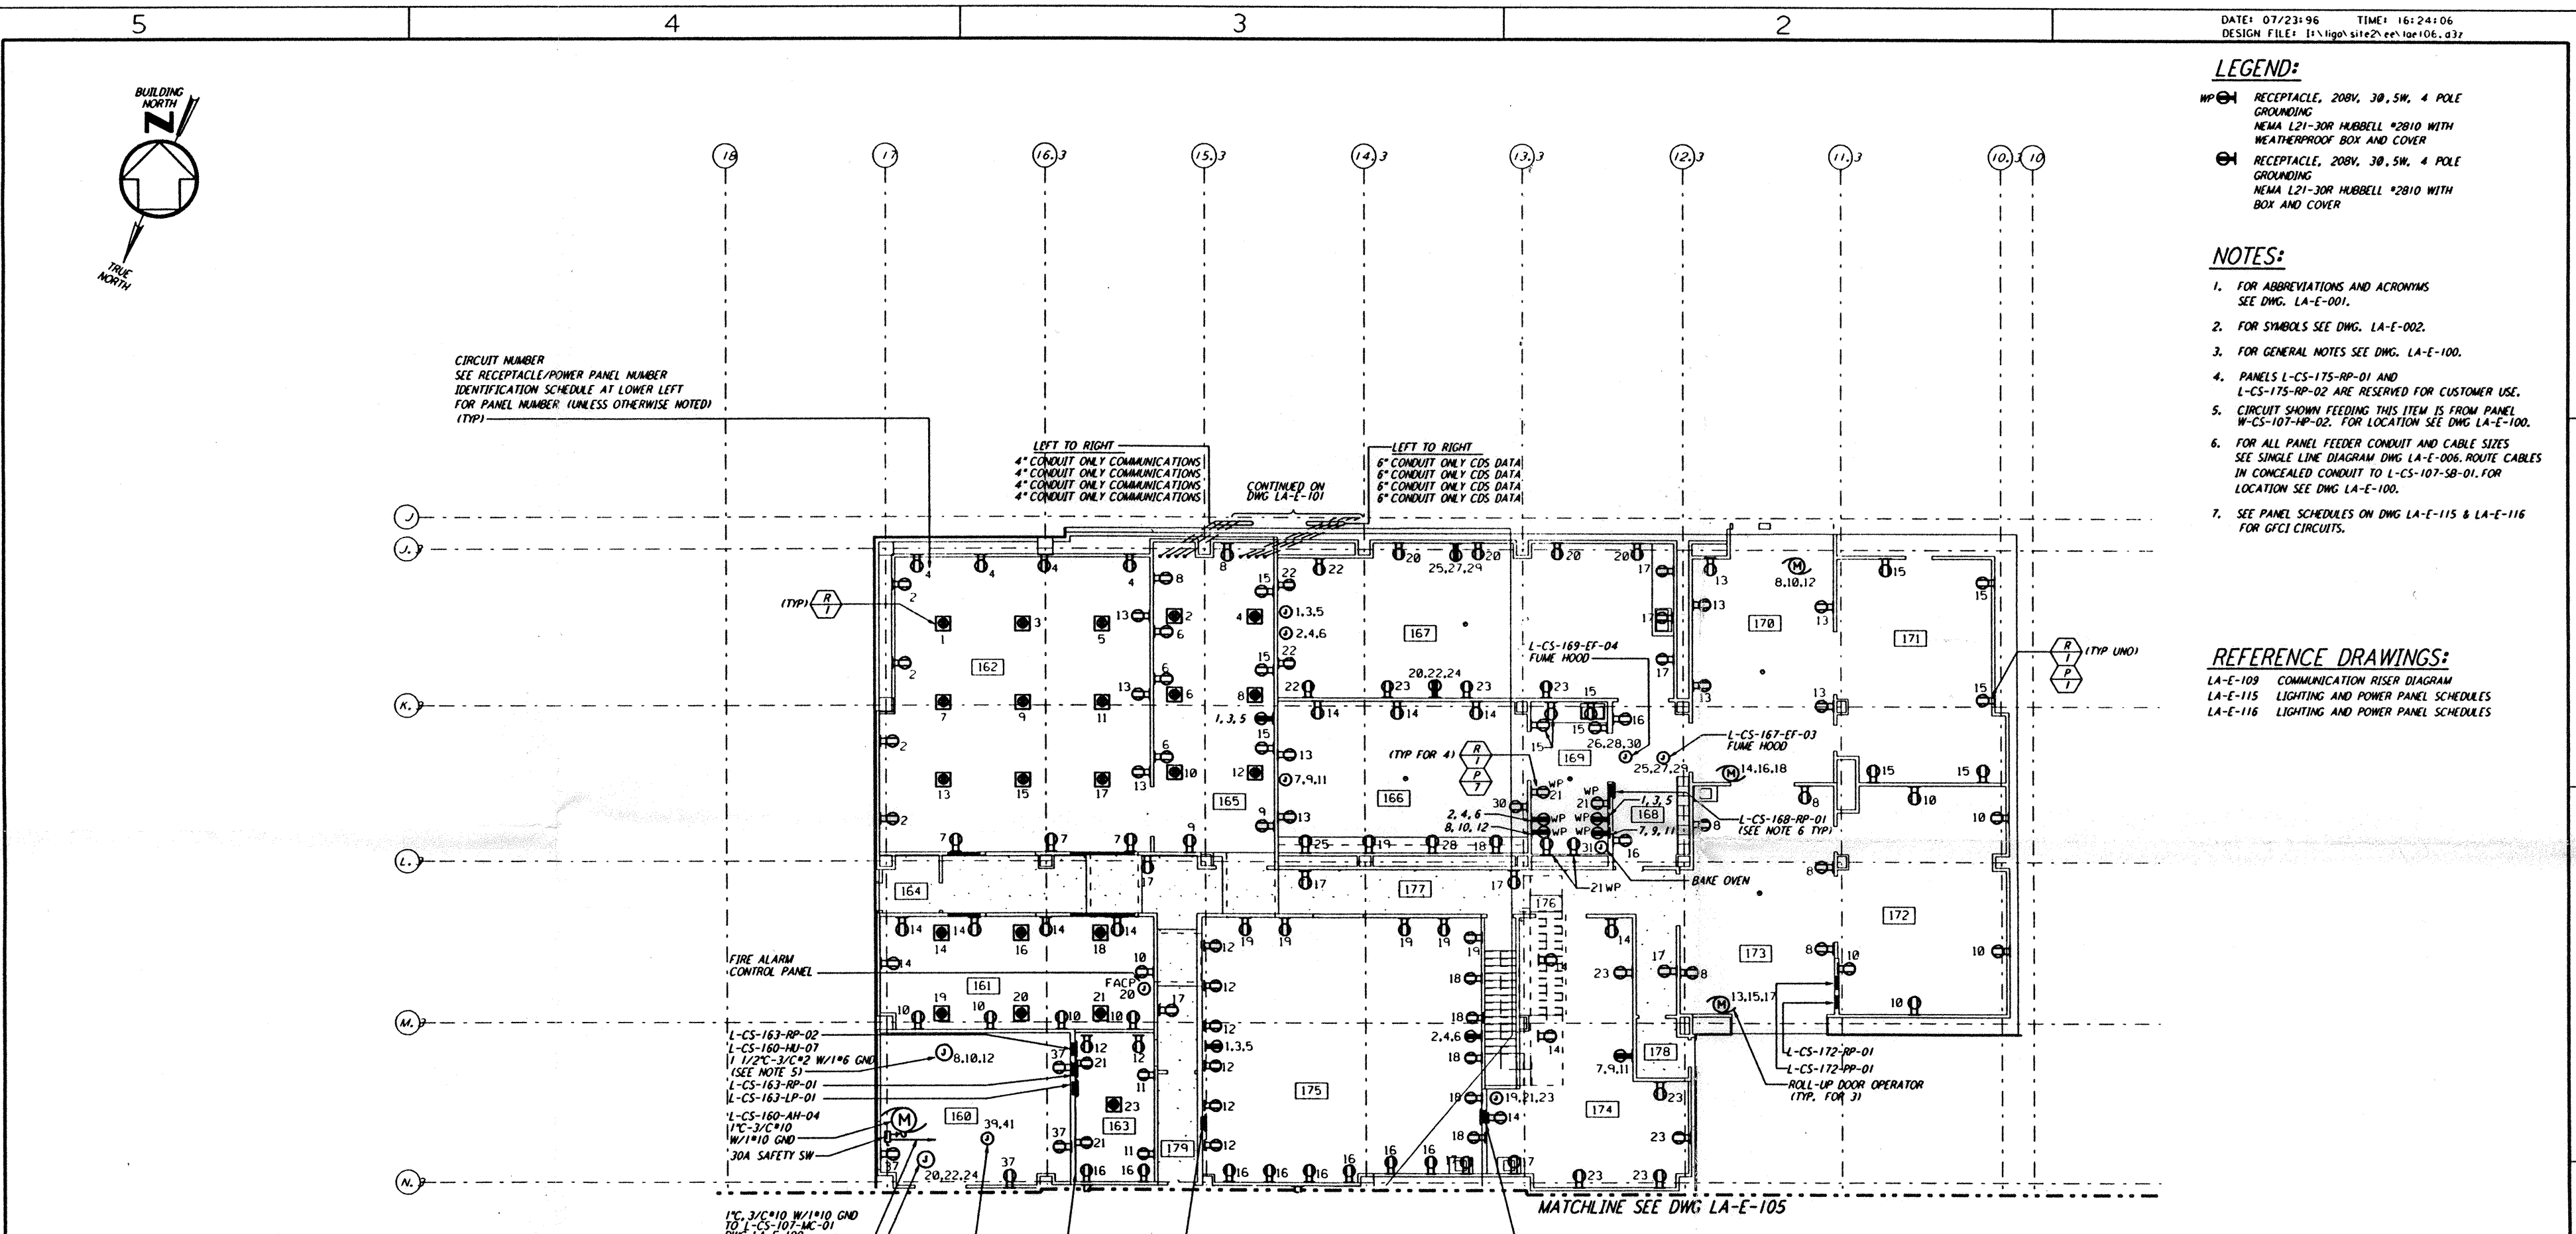

DRAWN: M.M. CHECKED: ENGINEER: PROJ:	ISSUED FOR BID FINAL DESIGN REVIEW PRELIMINARY DESIGN REVIEW
REVISIONS: C 7-24-96 MM JCL TDM B 8-14-96 MM JCL RR TDM A 10-31-95 TDM	DESCRIPTION: NO. DATE BY CHKD ENGR PROJ

PARSONS
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 PASADENA, CALIFORNIA
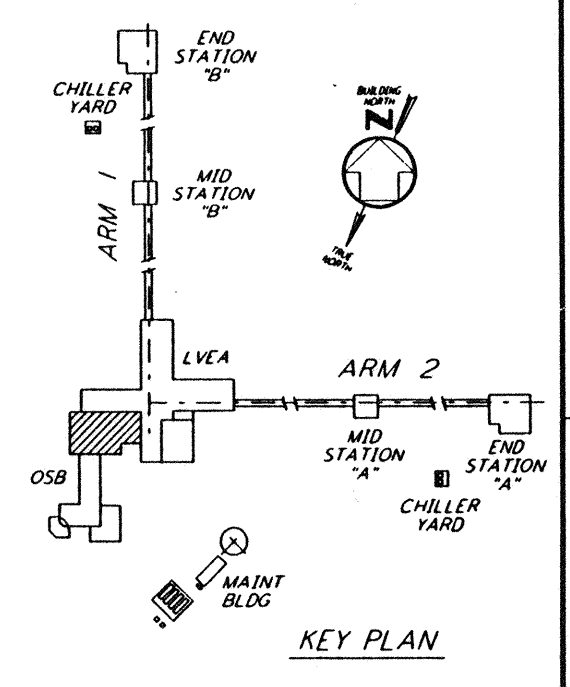
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LASER INTERFEROMETER
 GRAVITATIONAL-WAVE OBSERVATORY
 SITE NO. 2 - LIVINGSTON, LOUISIANA

TITLE: ELECTRICAL CORNER STATION OSB LAB AREA RECEPTACLE & POWER PLAN
 SCALE: AS NOTED
 CONTRACT NUMBER: PP150969
 PROJECT NUMBER: 8094

LA-E-106

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