



- NOTES:**
1. FOR LEGEND, ABBREVIATIONS AND GENERAL NOTES SEE SHEET LA-H-001 AND LA-H-002.
  2. MAINTAIN MINIMUM 6"-8" CLEAR HEIGHT UNDER PIPES, FOR PIPE SUPPORT DETAILS SEE STRUCTURAL DRAWING WA-S-407.
  3. PROVIDE FLOOR MOUNTED ELBOW SUPPORT AT THE PUMP SUCTION. CONTRACTOR MAY USE SUCTION DIFFUSER/STRAINER.
  4. REFER TO SPECIFICATIONS FOR PIPE SUPPORT REQUIREMENTS.
  5. SUPPORT PIPING TO ELIMINATE ANY LOADS TRANSMITTED FROM PIPING TO PUMPS AND CHILLERS.
  6. FOR PIPING FLOW DIAGRAM SEE SHEET LA-H-121.
  7. FOR VALVES AND CONTROL COMPONENTS SEE SHEET LA-H-121.
  8. PROVIDE FLEXIBLE CONNECTOR ON THE COMPRESSED AIR DISCHARGE.
  9. FOR CHILLERS AND PUMPS PIPING DETAILS SEE SHEETS LA-H-411 AND LA-H-412.
  10. FOR EXACT LOCATION OF THE CHILLERS AND PUMPS SEE CIVIL DRAWINGS.

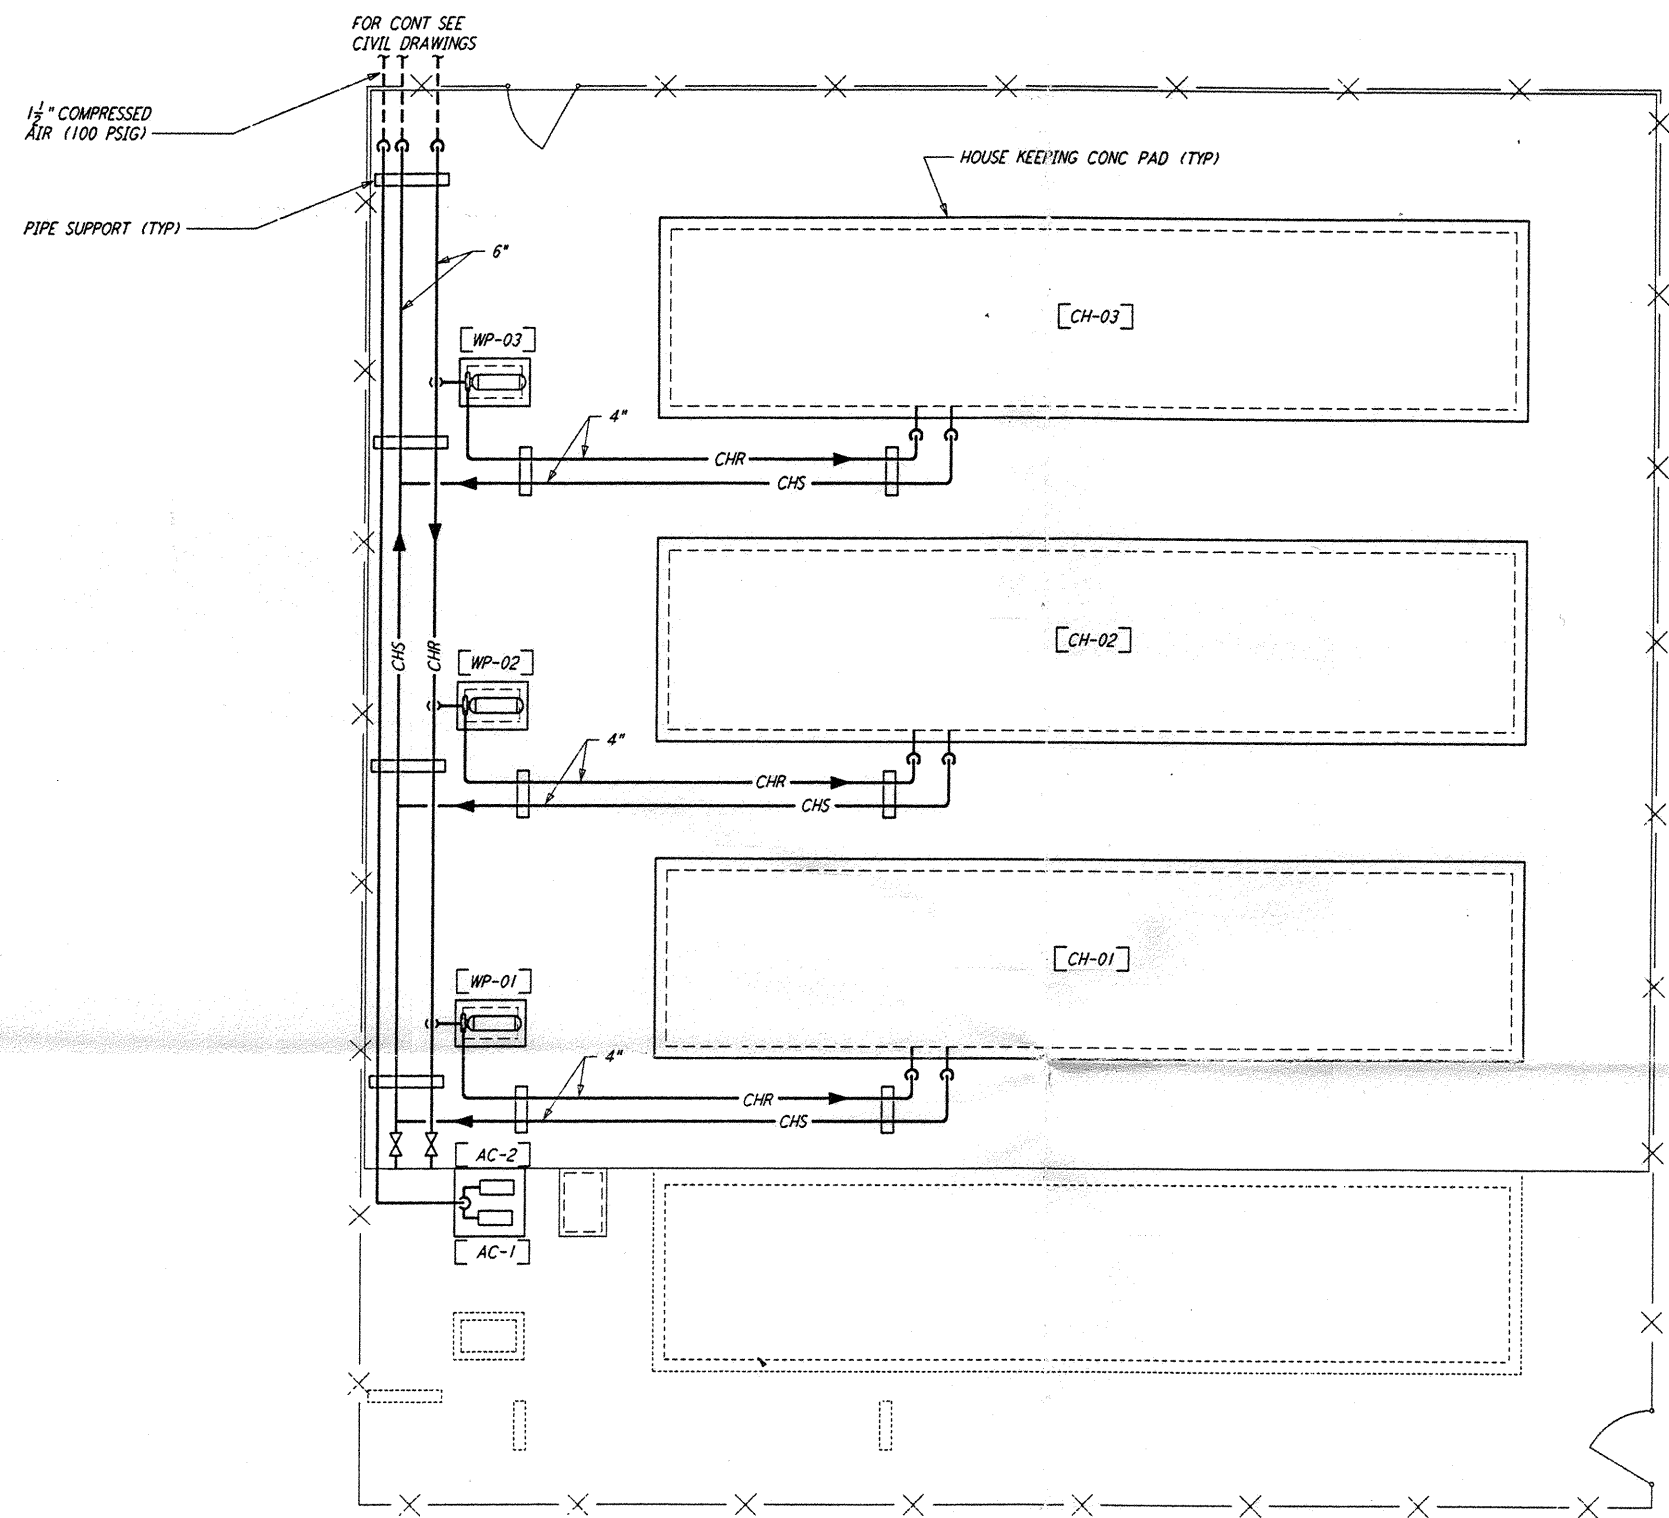

**CORNER STATION CHILLER YARD PLAN**  
 1/4" = 1'-0"

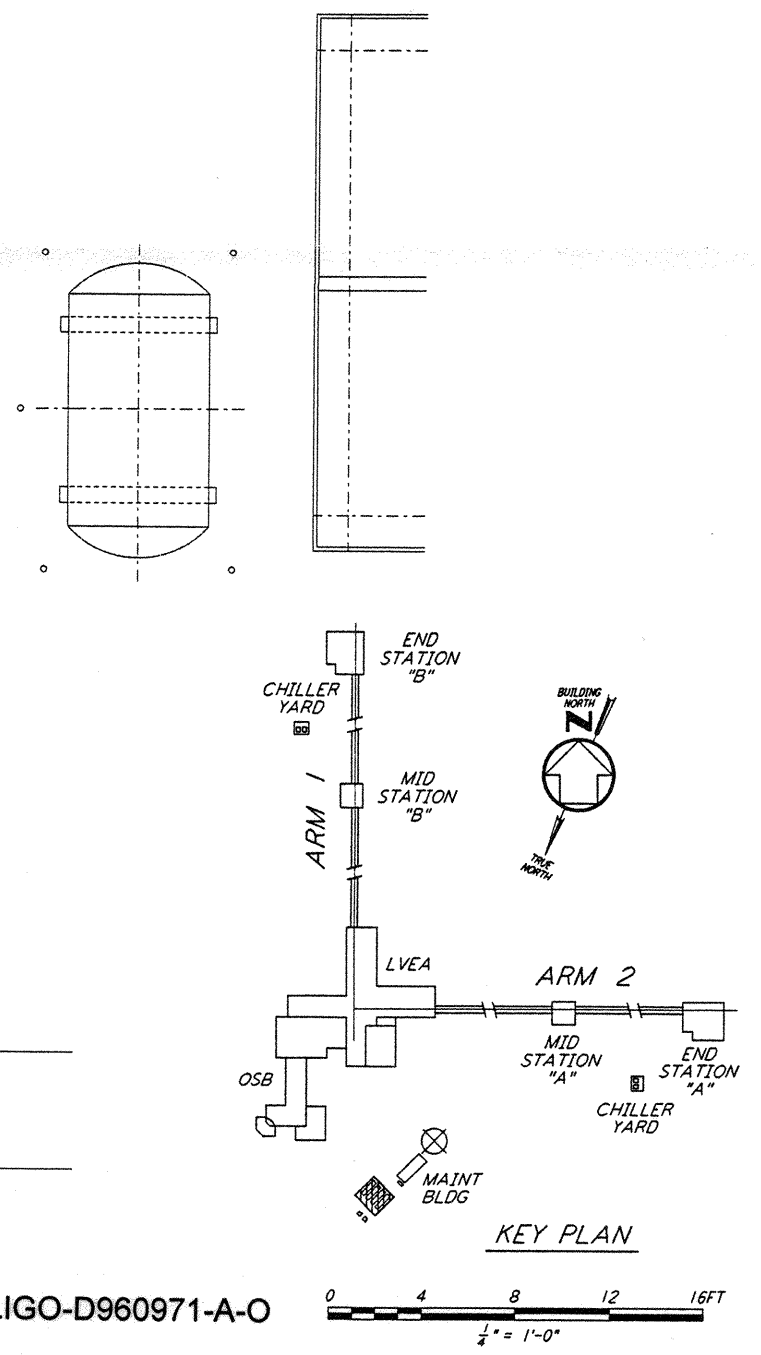

LIGO-D960971-A-O  
 1/4" = 1'-0"

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NO.	DATE	BY	CHKD	ENGR	PROJ	DESCRIPTION
A	6-14-96	CLP	AK	AK	AK	FINAL DESIGN REVIEW

DRAWN	CLP
CHECKED	
ENGINEER	
PROJ	

**PARSONS**  
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 MASSACHUSETTS INSTITUTE OF TECHNOLOGY

LASER INTERFEROMETER GRAVITATIONAL-WAVE OBSERVATORY SITE NO. 2 - LIVINGSTON, LOUISIANA		
TITLE	SCALE	CONTRACT NUMBER
HVAC CORNER STATION CHILLERS YARD FLOOR PLAN	AS NOTED	PP150969
	SHEET NUMBER	PROJECT NUMBER
	<b>LA-H-115</b>	8094
	REVISIONS	