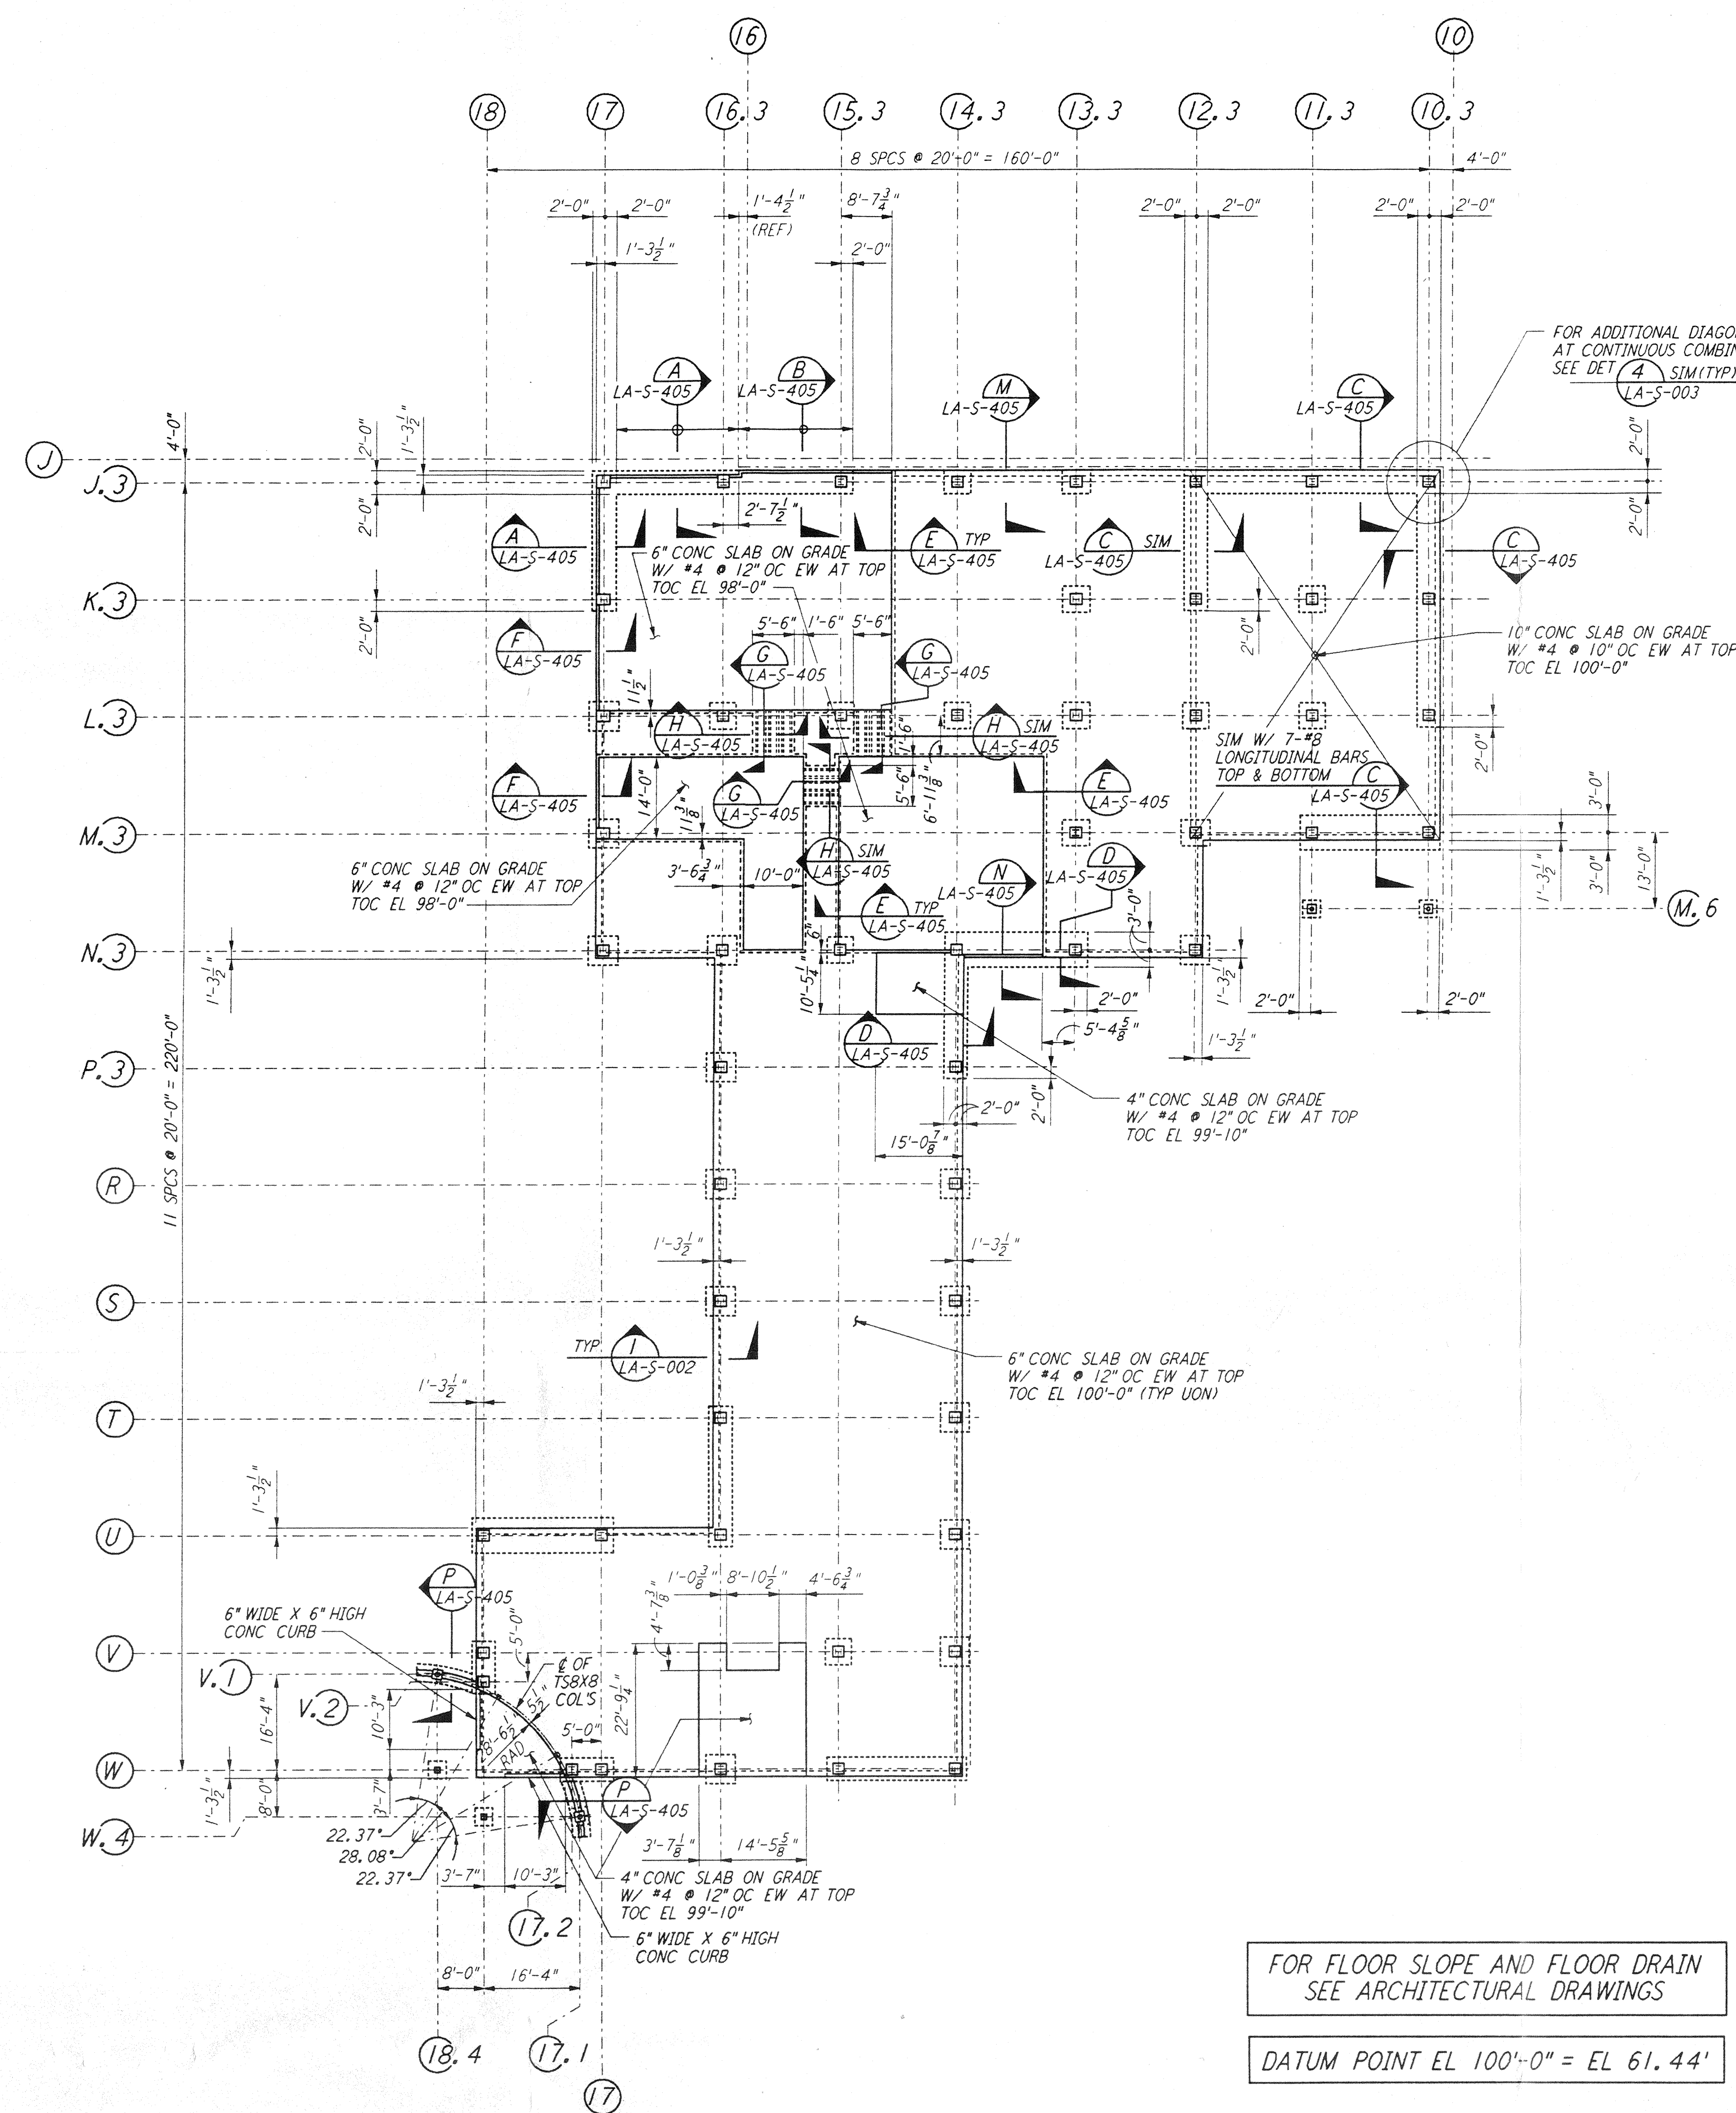
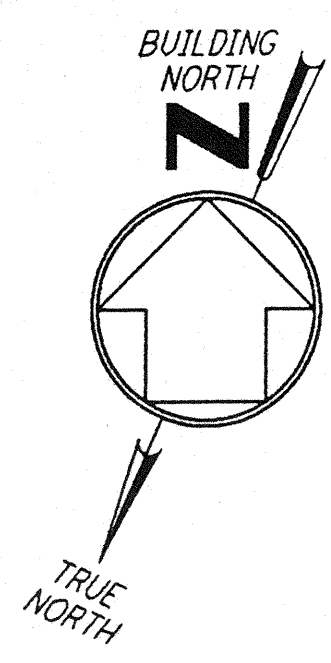


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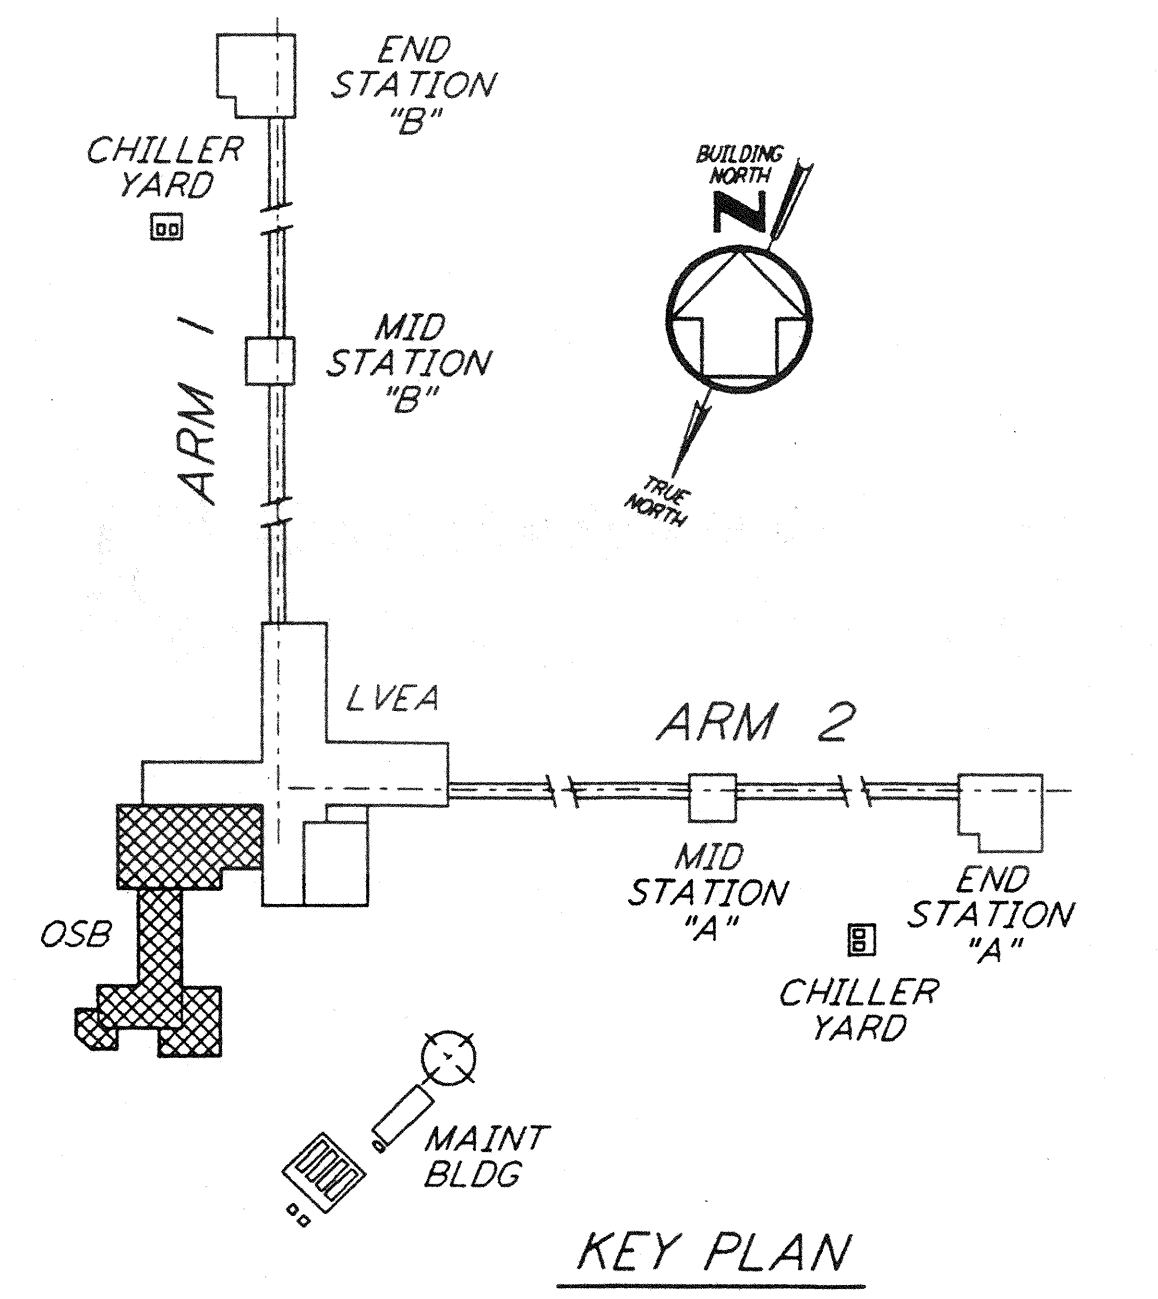
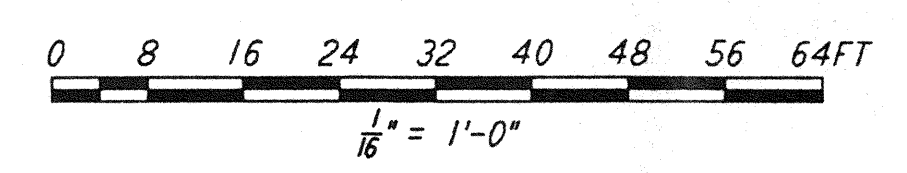


FOR FLOOR SLOPE AND FLOOR DRAIN
 SEE ARCHITECTURAL DRAWINGS

DATUM POINT EL 100'-0" = EL 61.44'

FOUNDATION PLAN
 1/8" = 1'-0"


- NOTES:**
- FOR GENERAL NOTES, ABBREVIATIONS AND SYMBOLS, SEE DRAWING LA-S-001.
 - FOR SLAB ON GRADE DETAILS SEE DRAWING LA-S-002.
 - FOR BASE ANGLE AT EDGE OF SLAB OR TOP OF 6" CONCRETE WALL, SEE FRAMING ELEVATIONS AND SECTION LA-S-003.
 - FOR FOUNDATION SCHEDULE AND DETAILS SEE DRAWINGS LA-S-402 AND LA-S-403.
 - ALL VERTICAL SURFACES OF FOUNDATION SHALL BE FORMED.



KEY PLAN

NO.	DATE	BY	CHK'D	ENGR	PROJ	DESCRIPTION

ISSUED FOR CONSTRUCTION	
DRAWN	MCS 11-15-96
CHECKED	11-15-96
ENGINEER	11-15-96
PROJ	11/15/96

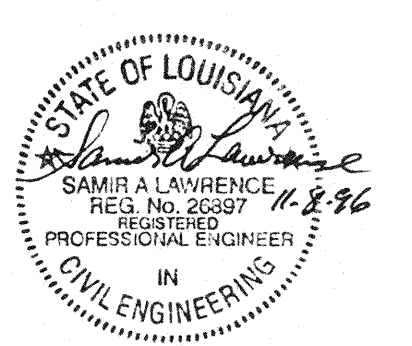

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 PASADENA, CALIFORNIA

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CALIFORNIA INSTITUTE OF TECHNOLOGY
 MASSACHUSETTS INSTITUTE OF TECHNOLOGY

LASER INTERFEROMETER
 GRAVITATIONAL-WAVE OBSERVATORY
 SITE NO. 2 - LIVINGSTON, LOUISIANA

**STRUCTURAL
 CORNER STATION
 OSB FOUNDATION PLAN**

SCALE: AS NOTED
 CONTRACT NUMBER: PP150969
 PROJECT NUMBER: 8094

SHEET NUMBER: **LA-S-102**

1160-D960918-00-0