
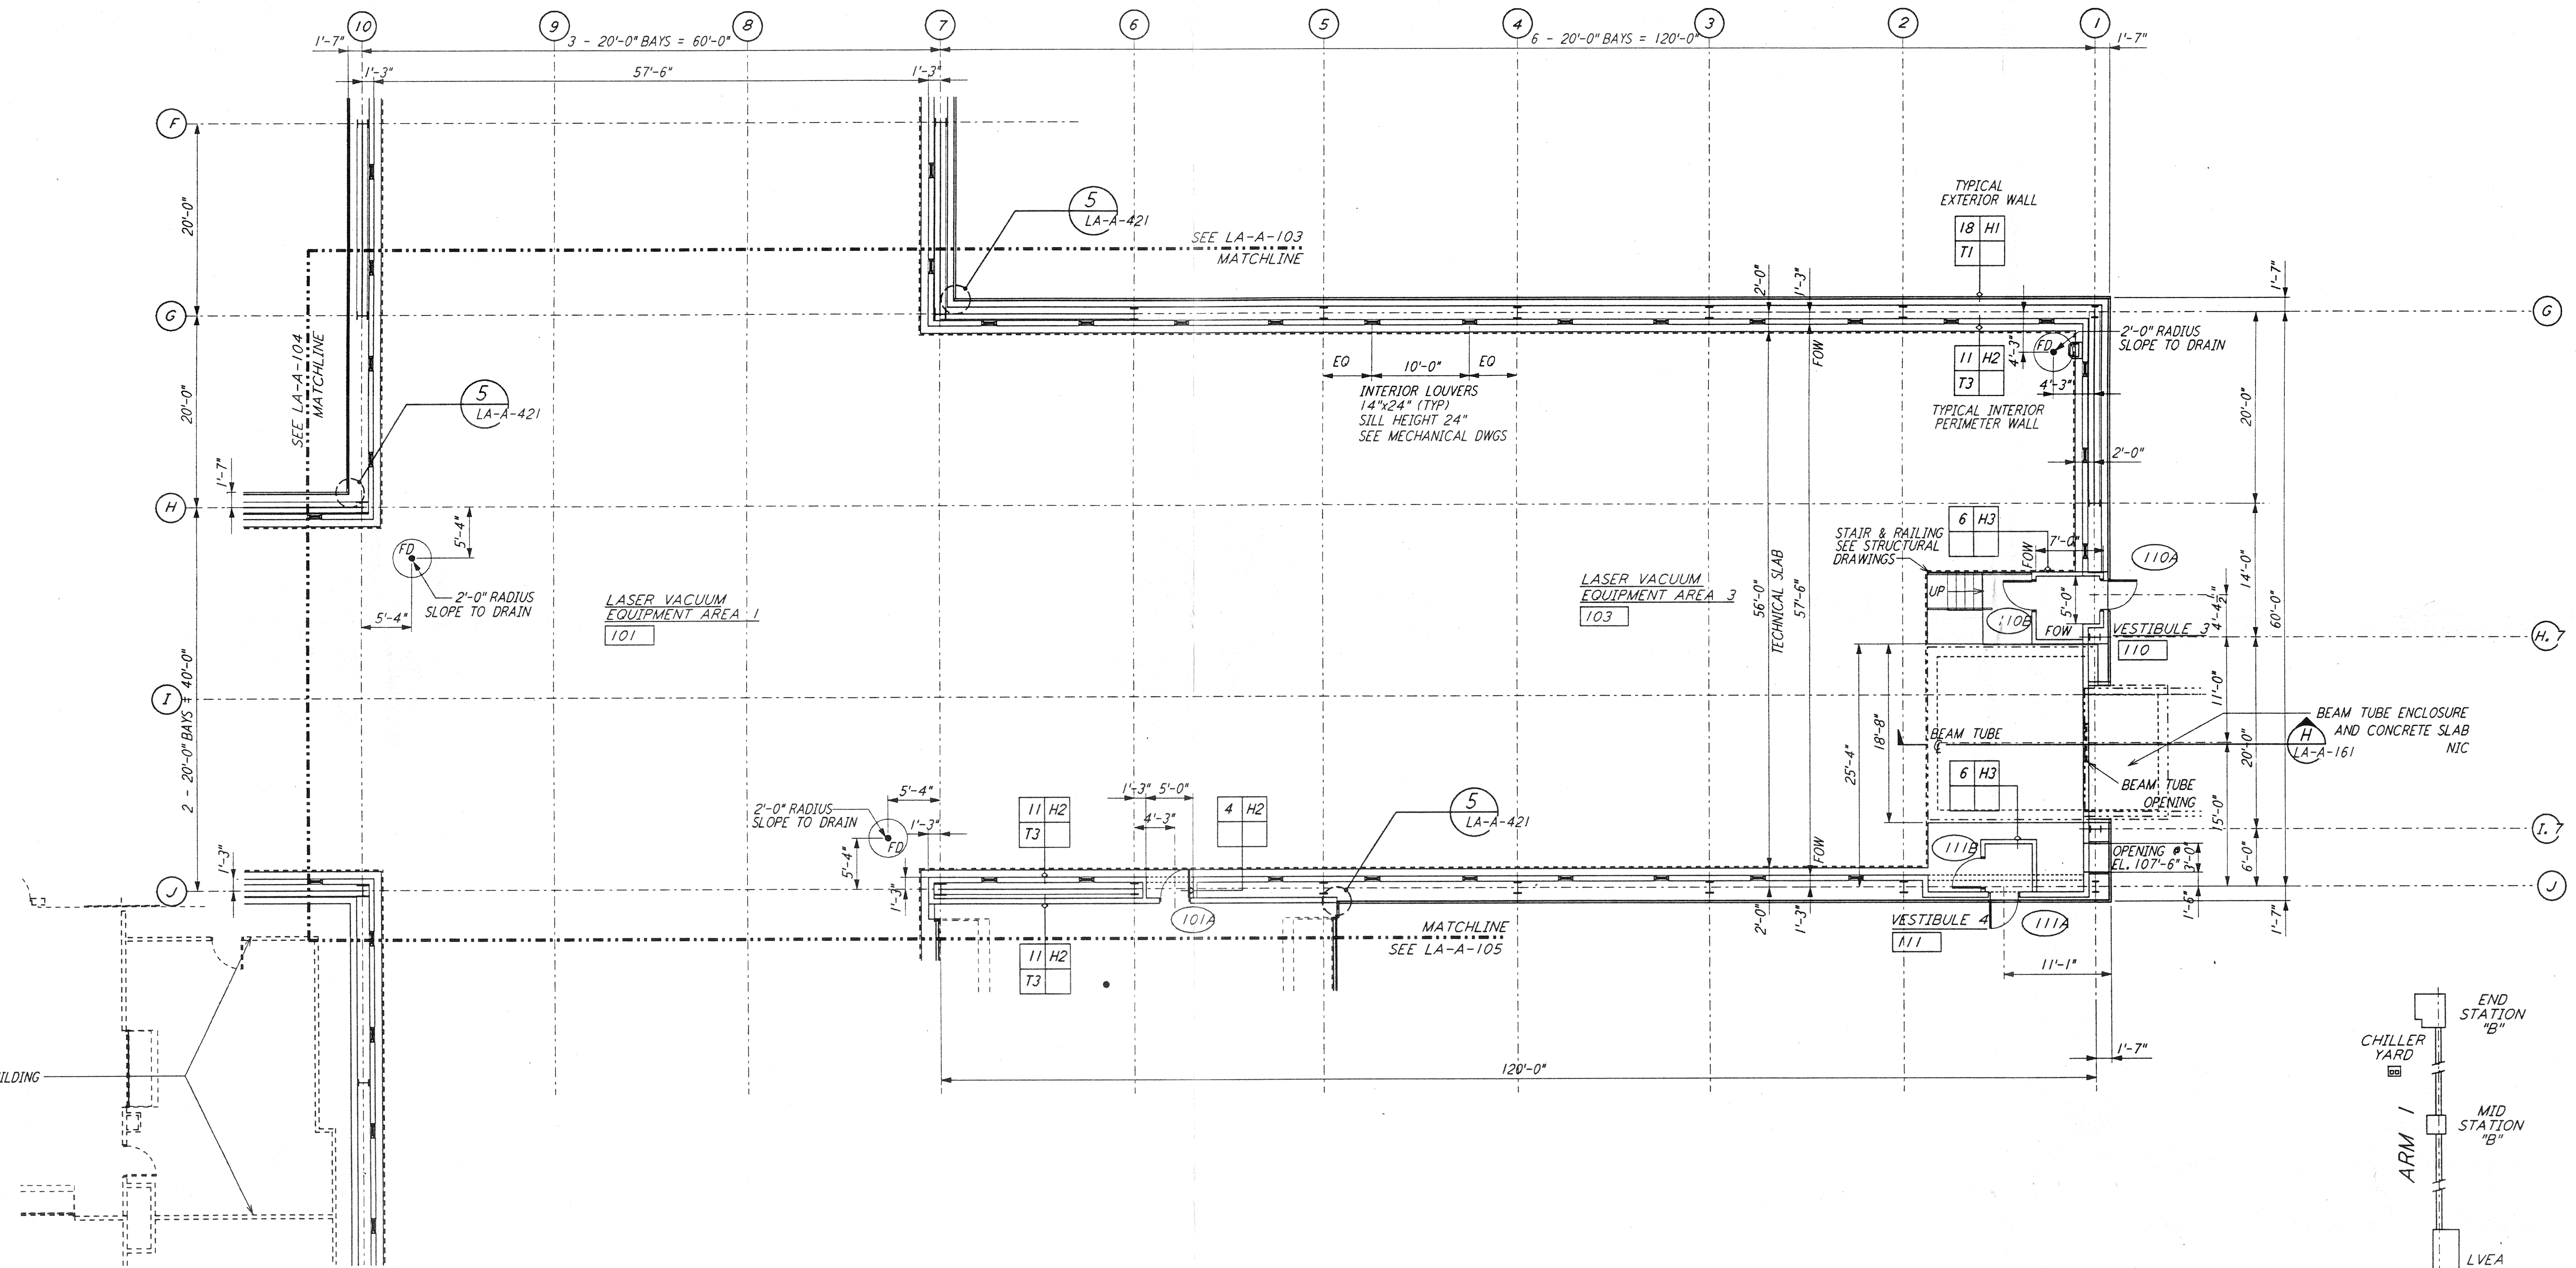


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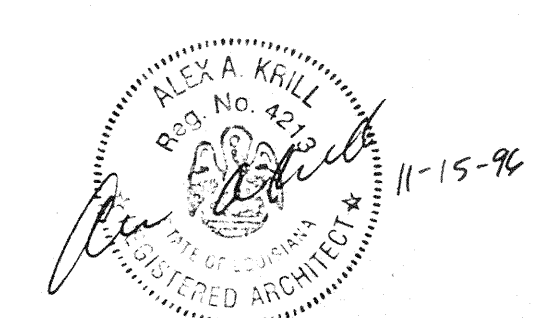
LINE OF OPERATIONAL SUPPORT BUILDING
SEE SHEET LA-A-109

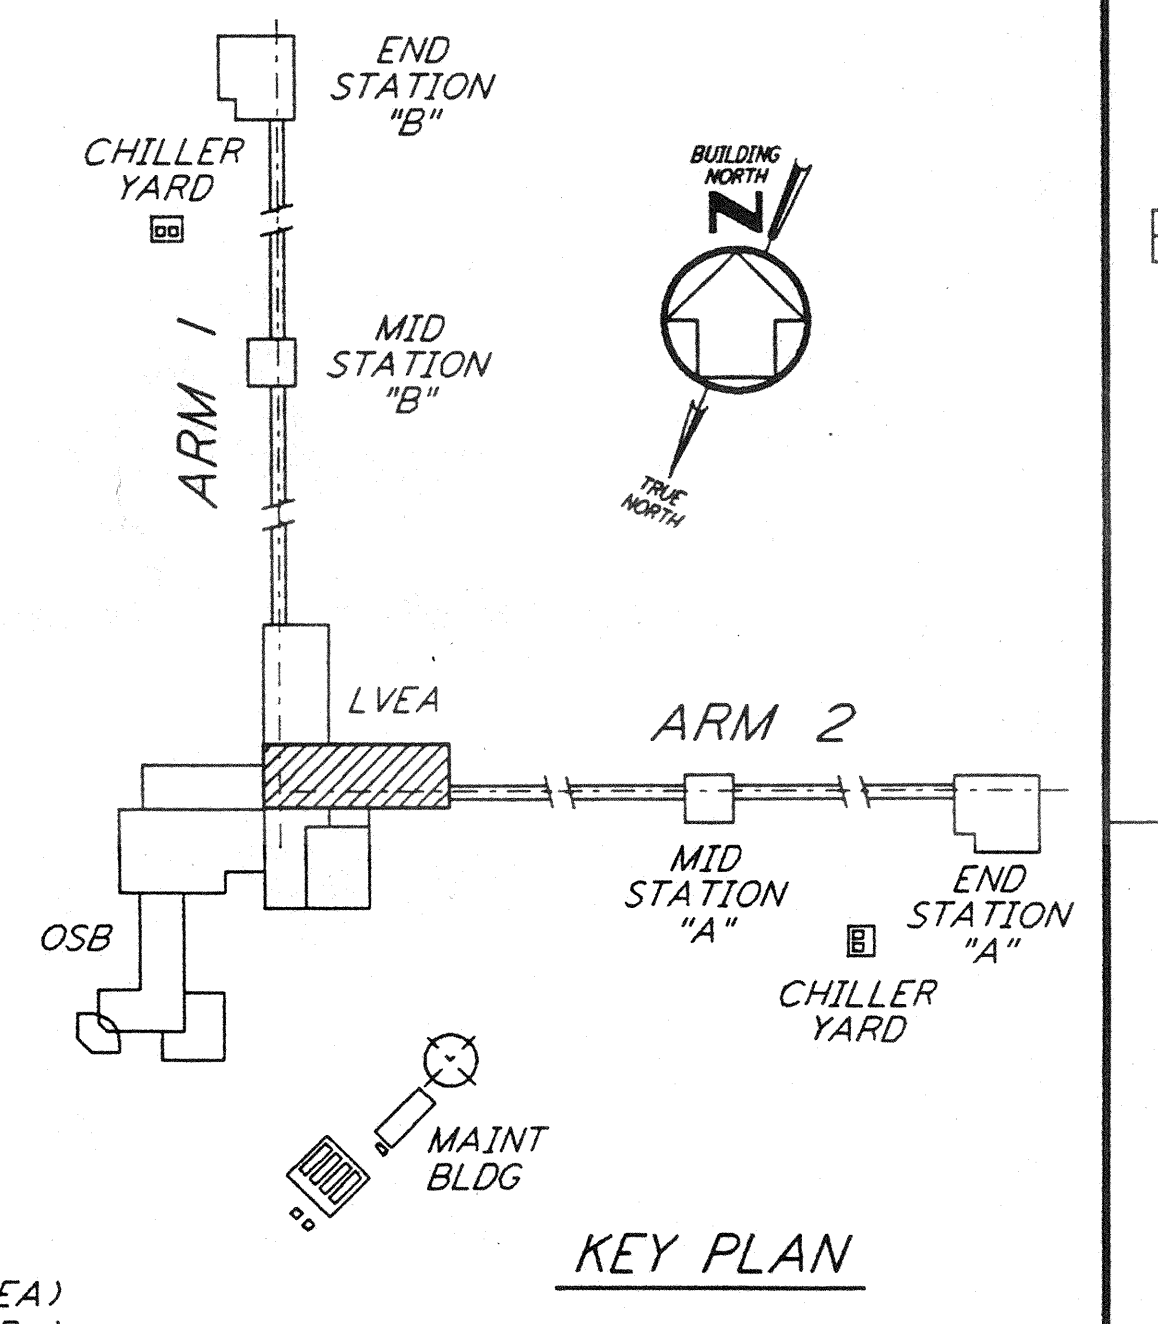

0 8 16 24 32 FT
1/8" = 1'-0"
DATUM POINT EL +100.00 = 61.44' (LVEA)
DATUM POINT EL +100.00 = 61.44' (OSB)

NO.	DATE	BY	CHKD	ENGR	PROJ	DESCRIPTION

ISSUED FOR CONSTRUCTION	
DRAWN	CKT 11-15-96
CHECKED	TB 11-15-96
ENGINEER	EF 11-15-96
PROJ	EDA 11/15/96



PARSONS
100 WEST WALNUT STREET
PASADENA, CALIFORNIA

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CALIFORNIA INSTITUTE OF TECHNOLOGY
MASSACHUSETTS INSTITUTE OF TECHNOLOGY

LASER INTERFEROMETER
GRAVITATIONAL-WAVE OBSERVATORY
SITE NO. 2 - LIVINGSTON, LOUISIANA

ARCHITECTURAL
CORNER STATION
LVEA PARTIAL FLOOR PLAN
SHEET 1

SCALE: AS NOTED
CONTRACT NUMBER: PPI 50969
PROJECT NUMBER: 8094
SHEET NUMBER: **LA-A-102**