
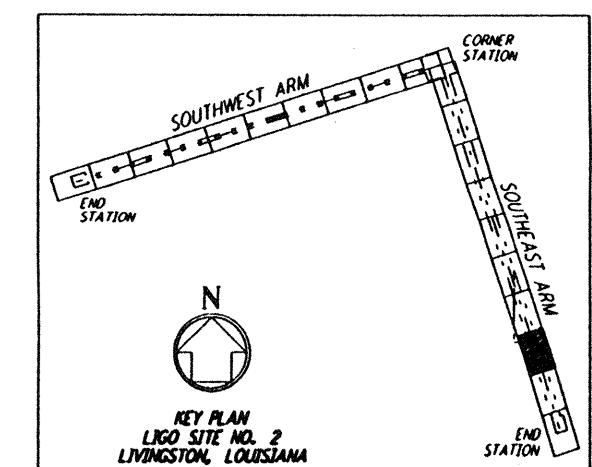


NOTES:  
1. SEE SHEET LA-C-002 FOR GENERAL NOTES, LEGEND AND ABBREVIATIONS.  
2. SEE SHEET LA-C-004 FOR TYPICAL SECTIONS AND DETAILS.

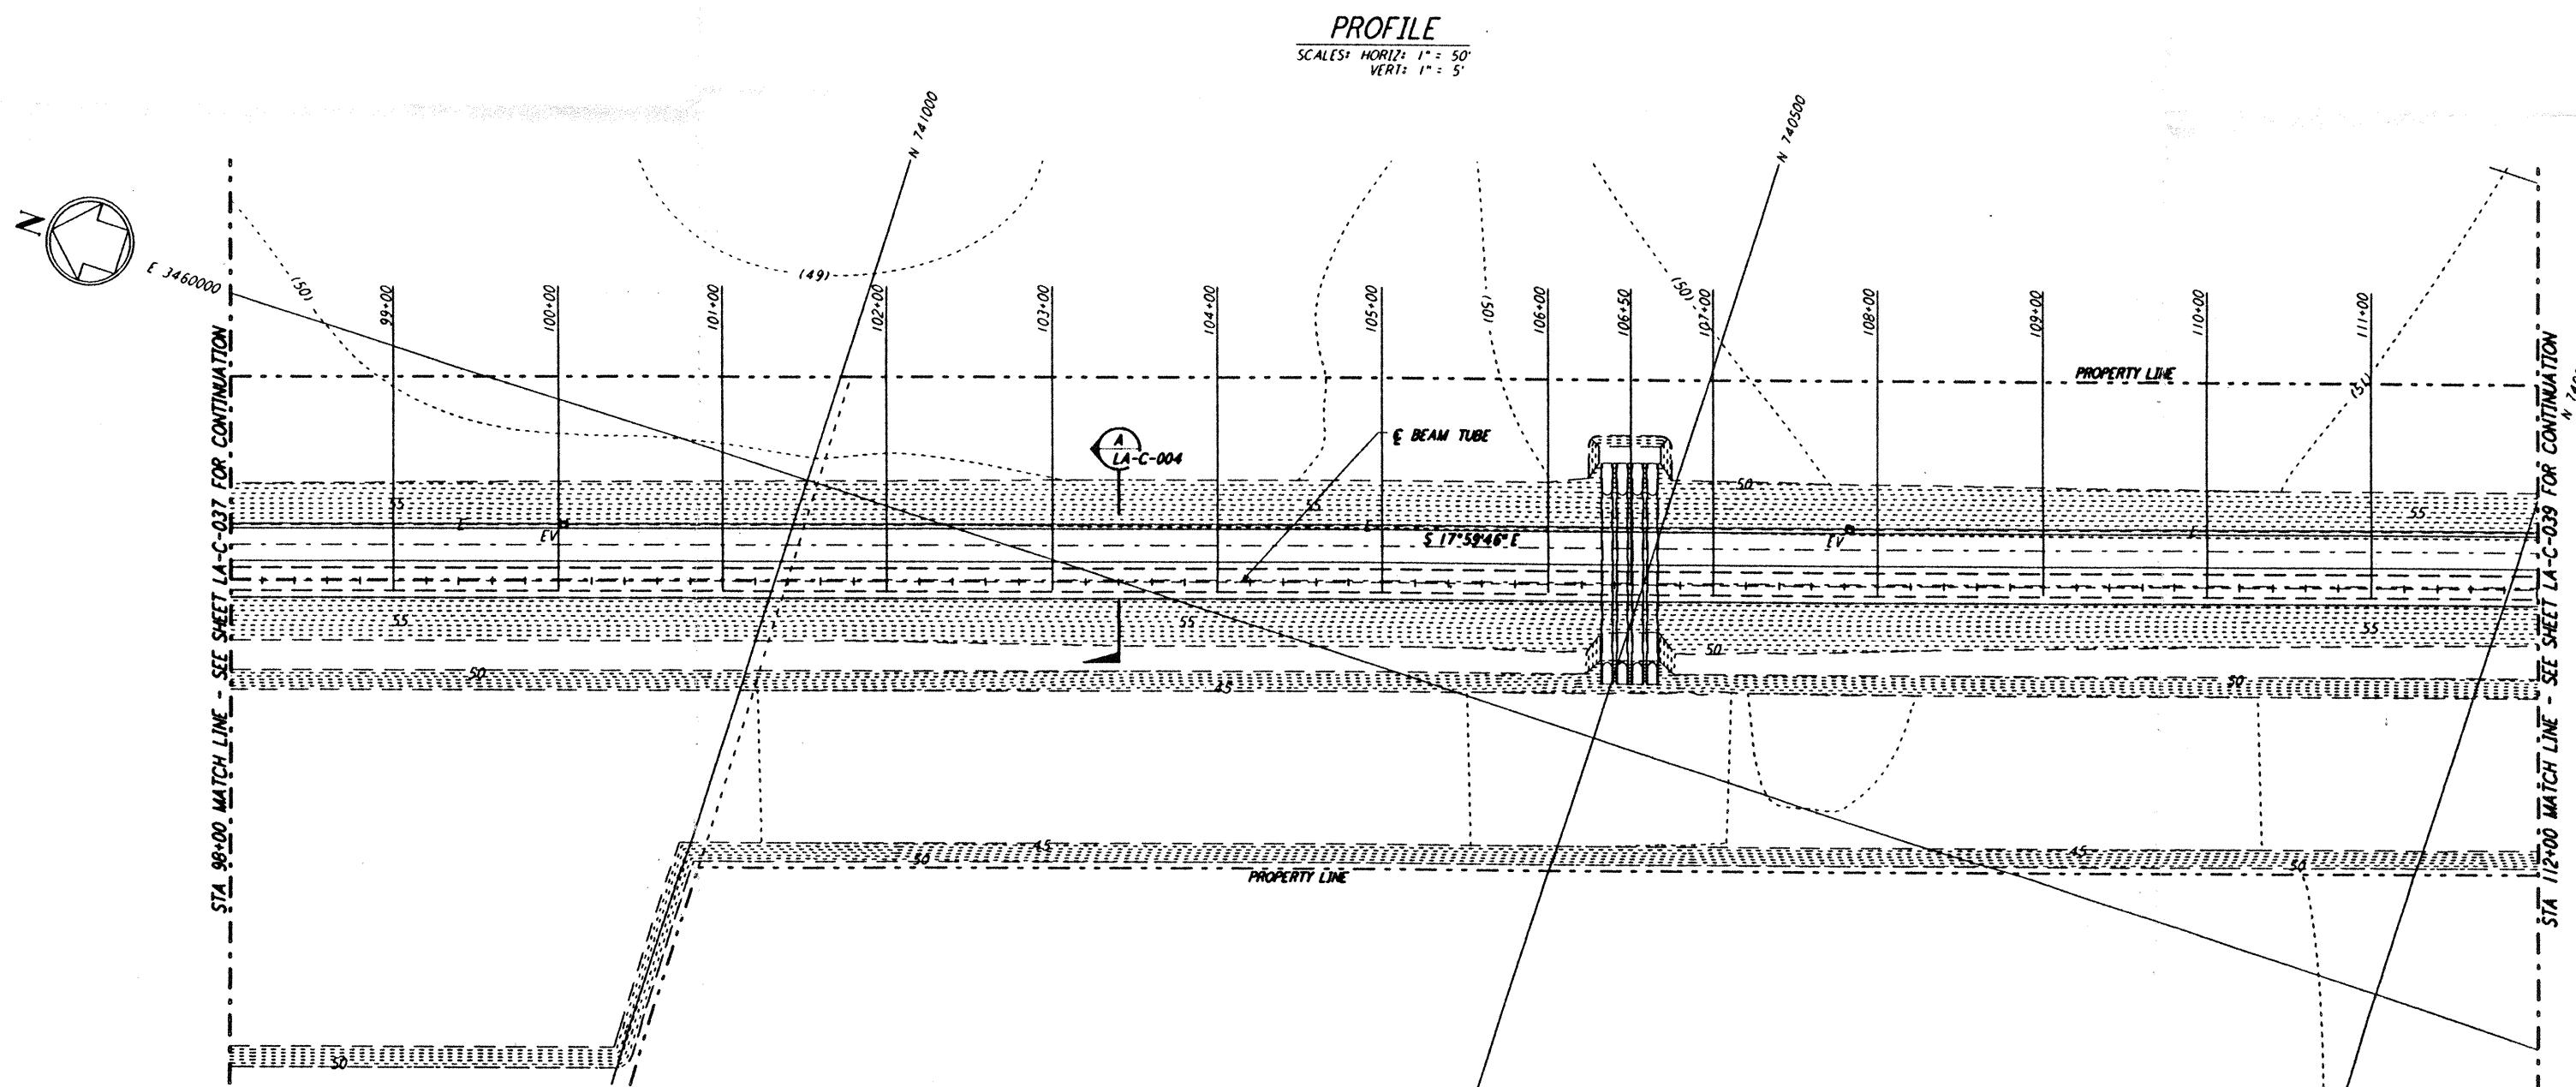

GRAPHIC SCALES  
0 50 100 150 200  
HORIZ SCALE: 1" = 50'  
0 5 10 15 20  
VERT SCALE: 1" = 5'

REFERENCES	REVISIONS	DRAWN	WRB	CHECKED	ENGR	PROJ	ISSUED FOR BID	FINAL DESIGN REVIEW	100 WEST WALNUT STREET PASADENA, CALIFORNIA	LIGO	CALIFORNIA INSTITUTE OF TECHNOLOGY MASSACHUSETTS INSTITUTE OF TECHNOLOGY	LASER INTERFEROMETER GRAVITATIONAL-WAVE OBSERVATORY SITE NO. 2 - LIVINGSTON, LOUISIANA	TITLE	SCALE	CONTACT NUMBER	PROJECT NUMBER	
DRAWING NO.	DESCRIPTION	B	T/24/96	WRB	ML	CB	ZDTN			PARSONS			CIVIL SOUTHWEST ARM PLAN AND PROFILE STA 98+00 TO STA 112+00	AS NOTED	PP150969	8094	
5	4	A	6/14/96	WRB	ML	CB	TDM						LA - C - 038	SHEET NUMBER	LIGO-D960852-B-O	I	LIGOLAF3.BDR