
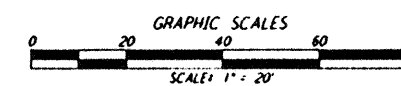
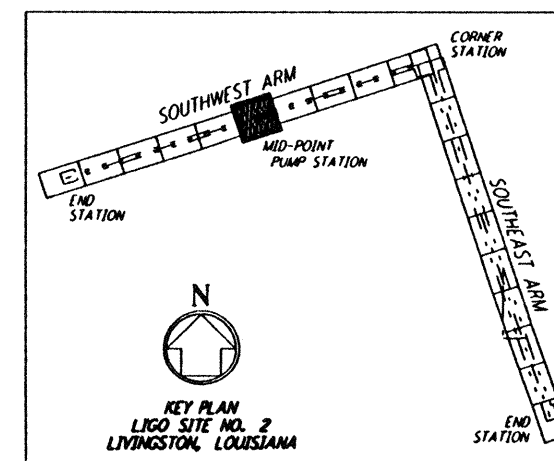


NOTES:
1. SEE SHEET LA-C-002 FOR GENERAL NOTES, LEGEND AND ABBREVIATIONS.

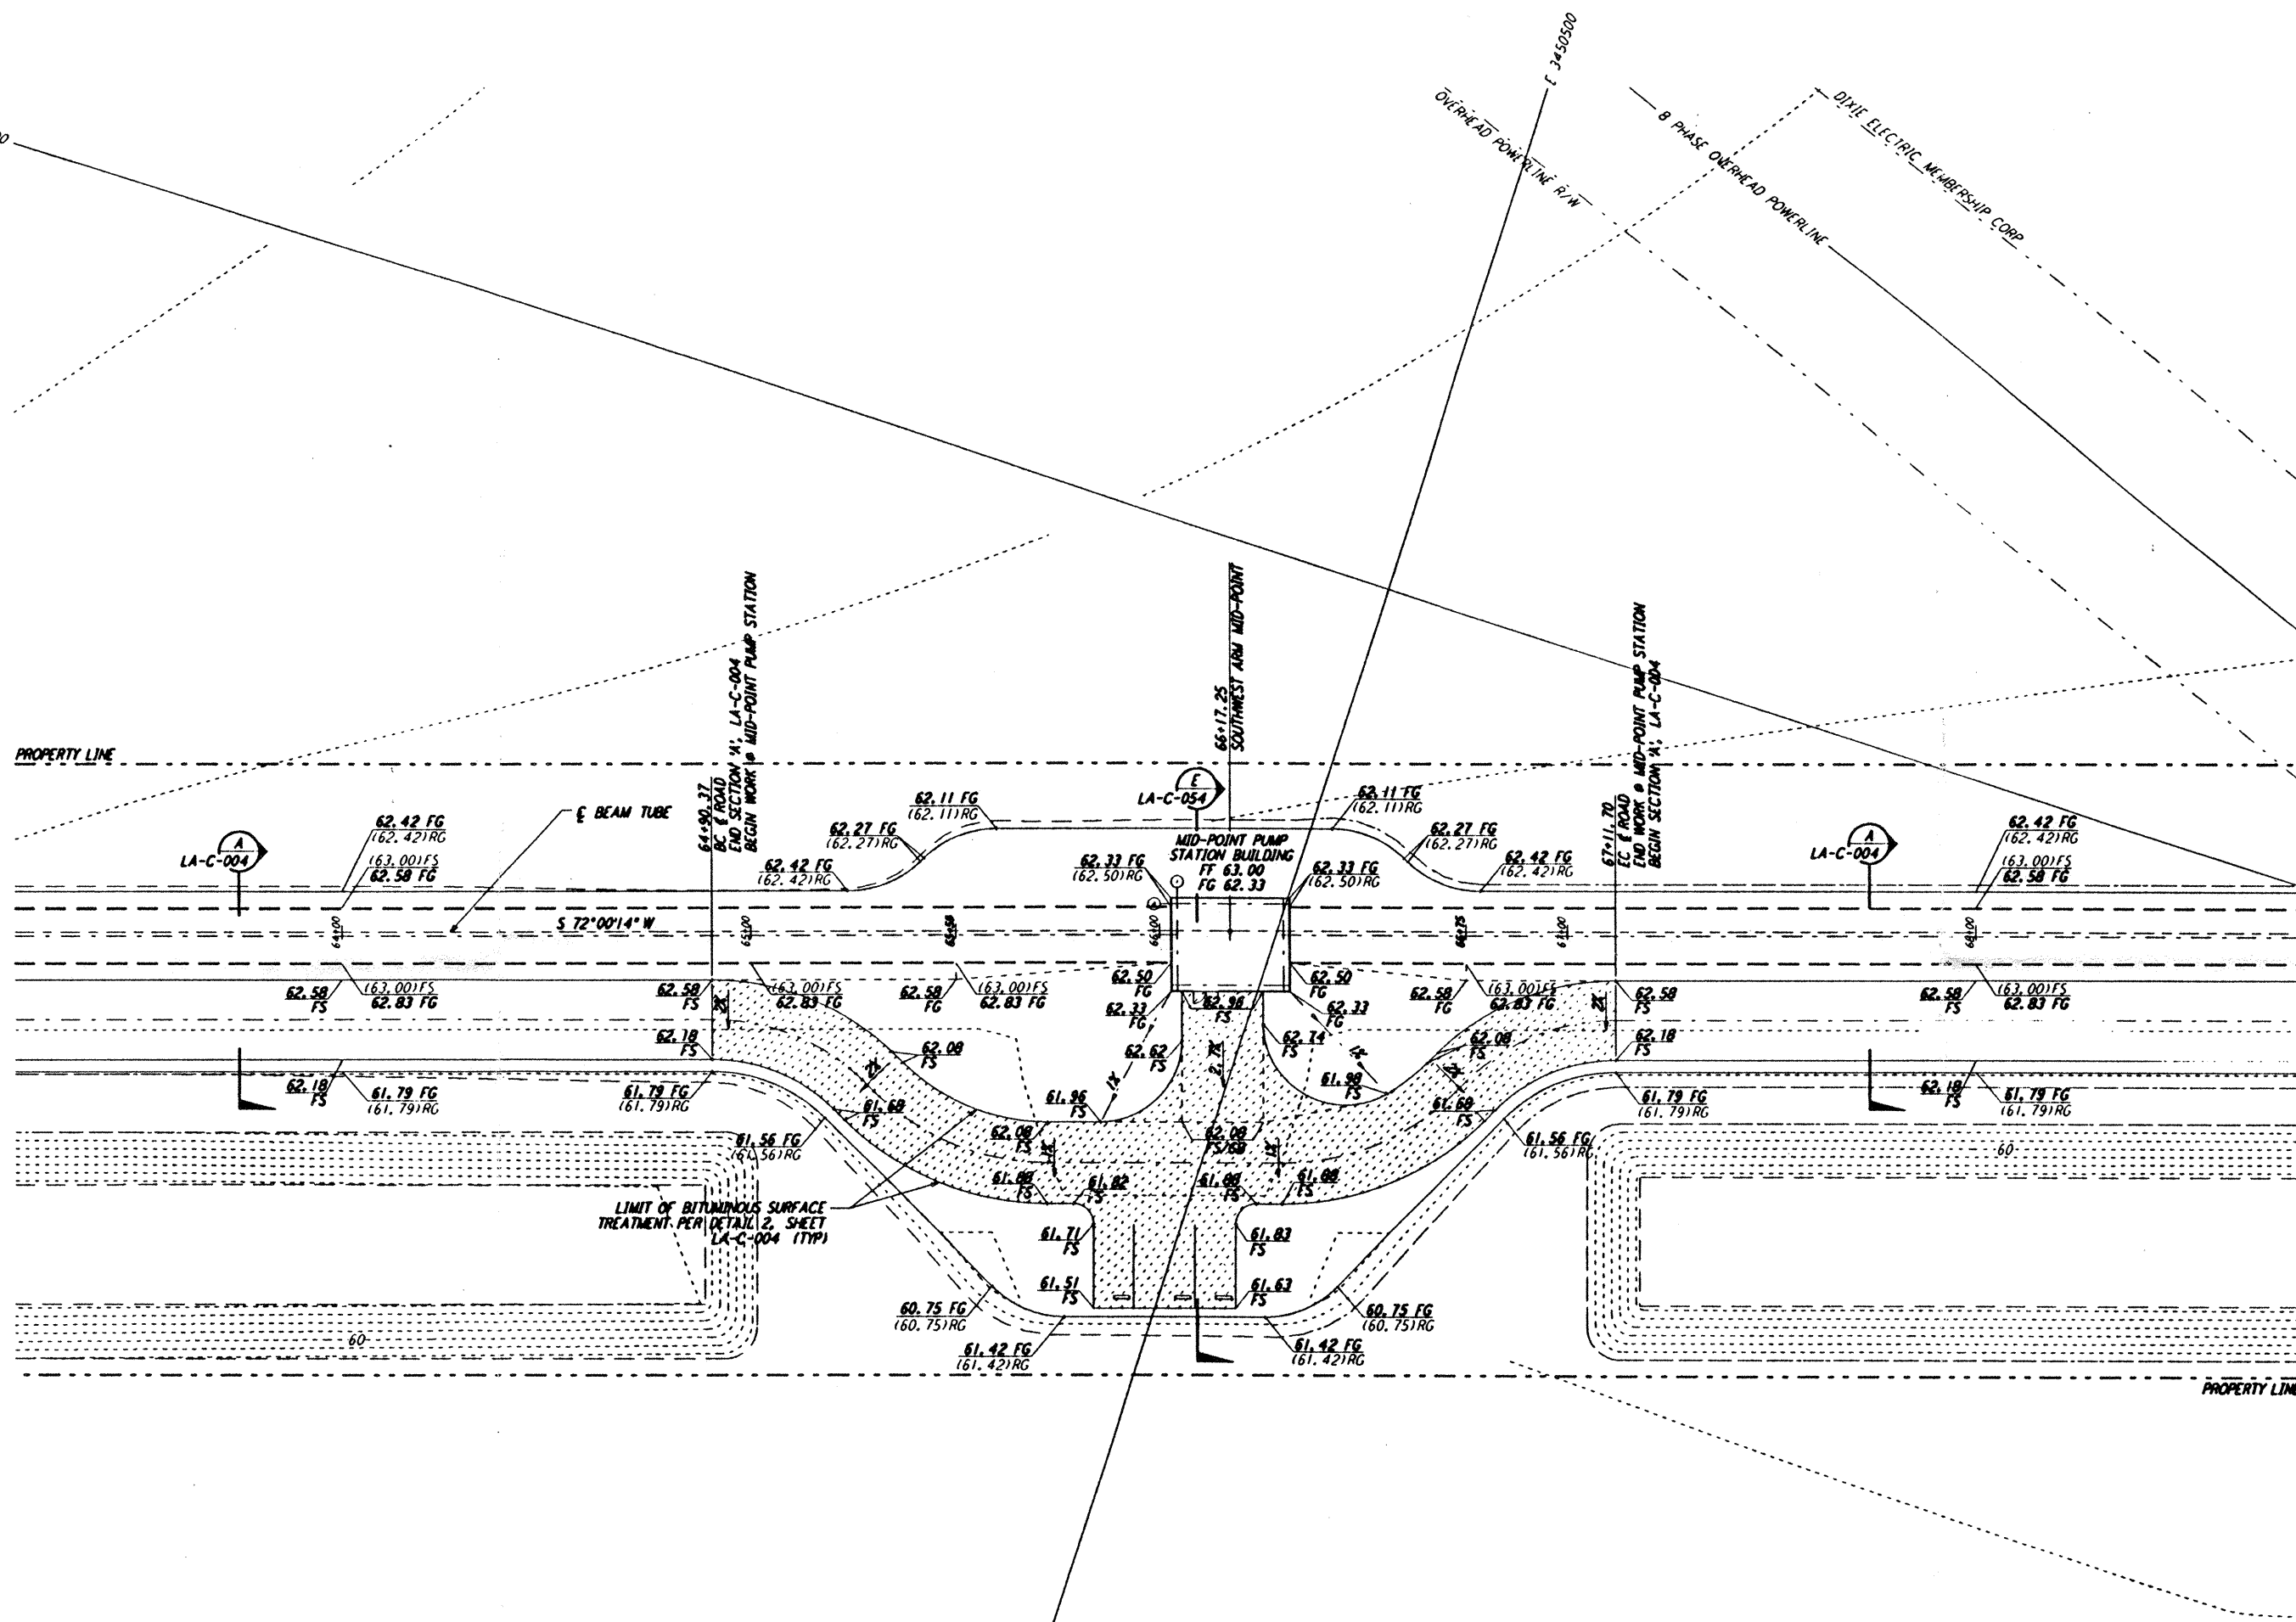

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NO.	DATE	BY	CHKD	ENGR	PROJ	DESCRIPTION
B	7/24/96	WRB	ML	CM	TDW	ISSUED FOR BID
A	6/14/96	WRB	ML	CB	TDW	FINAL DESIGN REVIEW

DRAWN	WRB
CHECKED	
ENGINEER	
PROJ	

PARSONS
100 WEST WALNUT STREET
PASADENA, CALIFORNIA

LIGO
CALIFORNIA INSTITUTE OF TECHNOLOGY
MASSACHUSETTS INSTITUTE OF TECHNOLOGY

LASER INTERFEROMETER
GRAVITATIONAL-WAVE OBSERVATORY
SITE NO. 2 - LIVINGSTON, LOUISIANA
CIVIL
SOUTHWEST ARM
PUMP STATION
GRADING PLAN
SCALE: 1" = 20'
CONTRACT NUMBER: PP150969
PROJECT NUMBER: 8094
SHEET NUMBER: LA-C-022

LIGO-D960840-B-O 1 LIGOLAF 3.BOR

E
D
C
B
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Mon Jul 22 09:24:36 1996 s3-v18b2 J:\PLOTS\QUEUES\18B2\CE022.PR