



- NOTES:**
- 1) CONDUIT IS SHOWN DIAGRAMMATICALLY AND SHALL BE FIELD VERIFIED SO AS TO OPTIMIZE SUPPORTING MEANS AND TO AVOID INTERFERENCES WITH PIPING SYSTEMS.
  - 2) IDENTIFY ALL CONNECTION BOXES WITH BLACK PHENOLIC TAGS WITH WHITE LETTERING. LETTERING SHALL BE 3/8" HIGH.

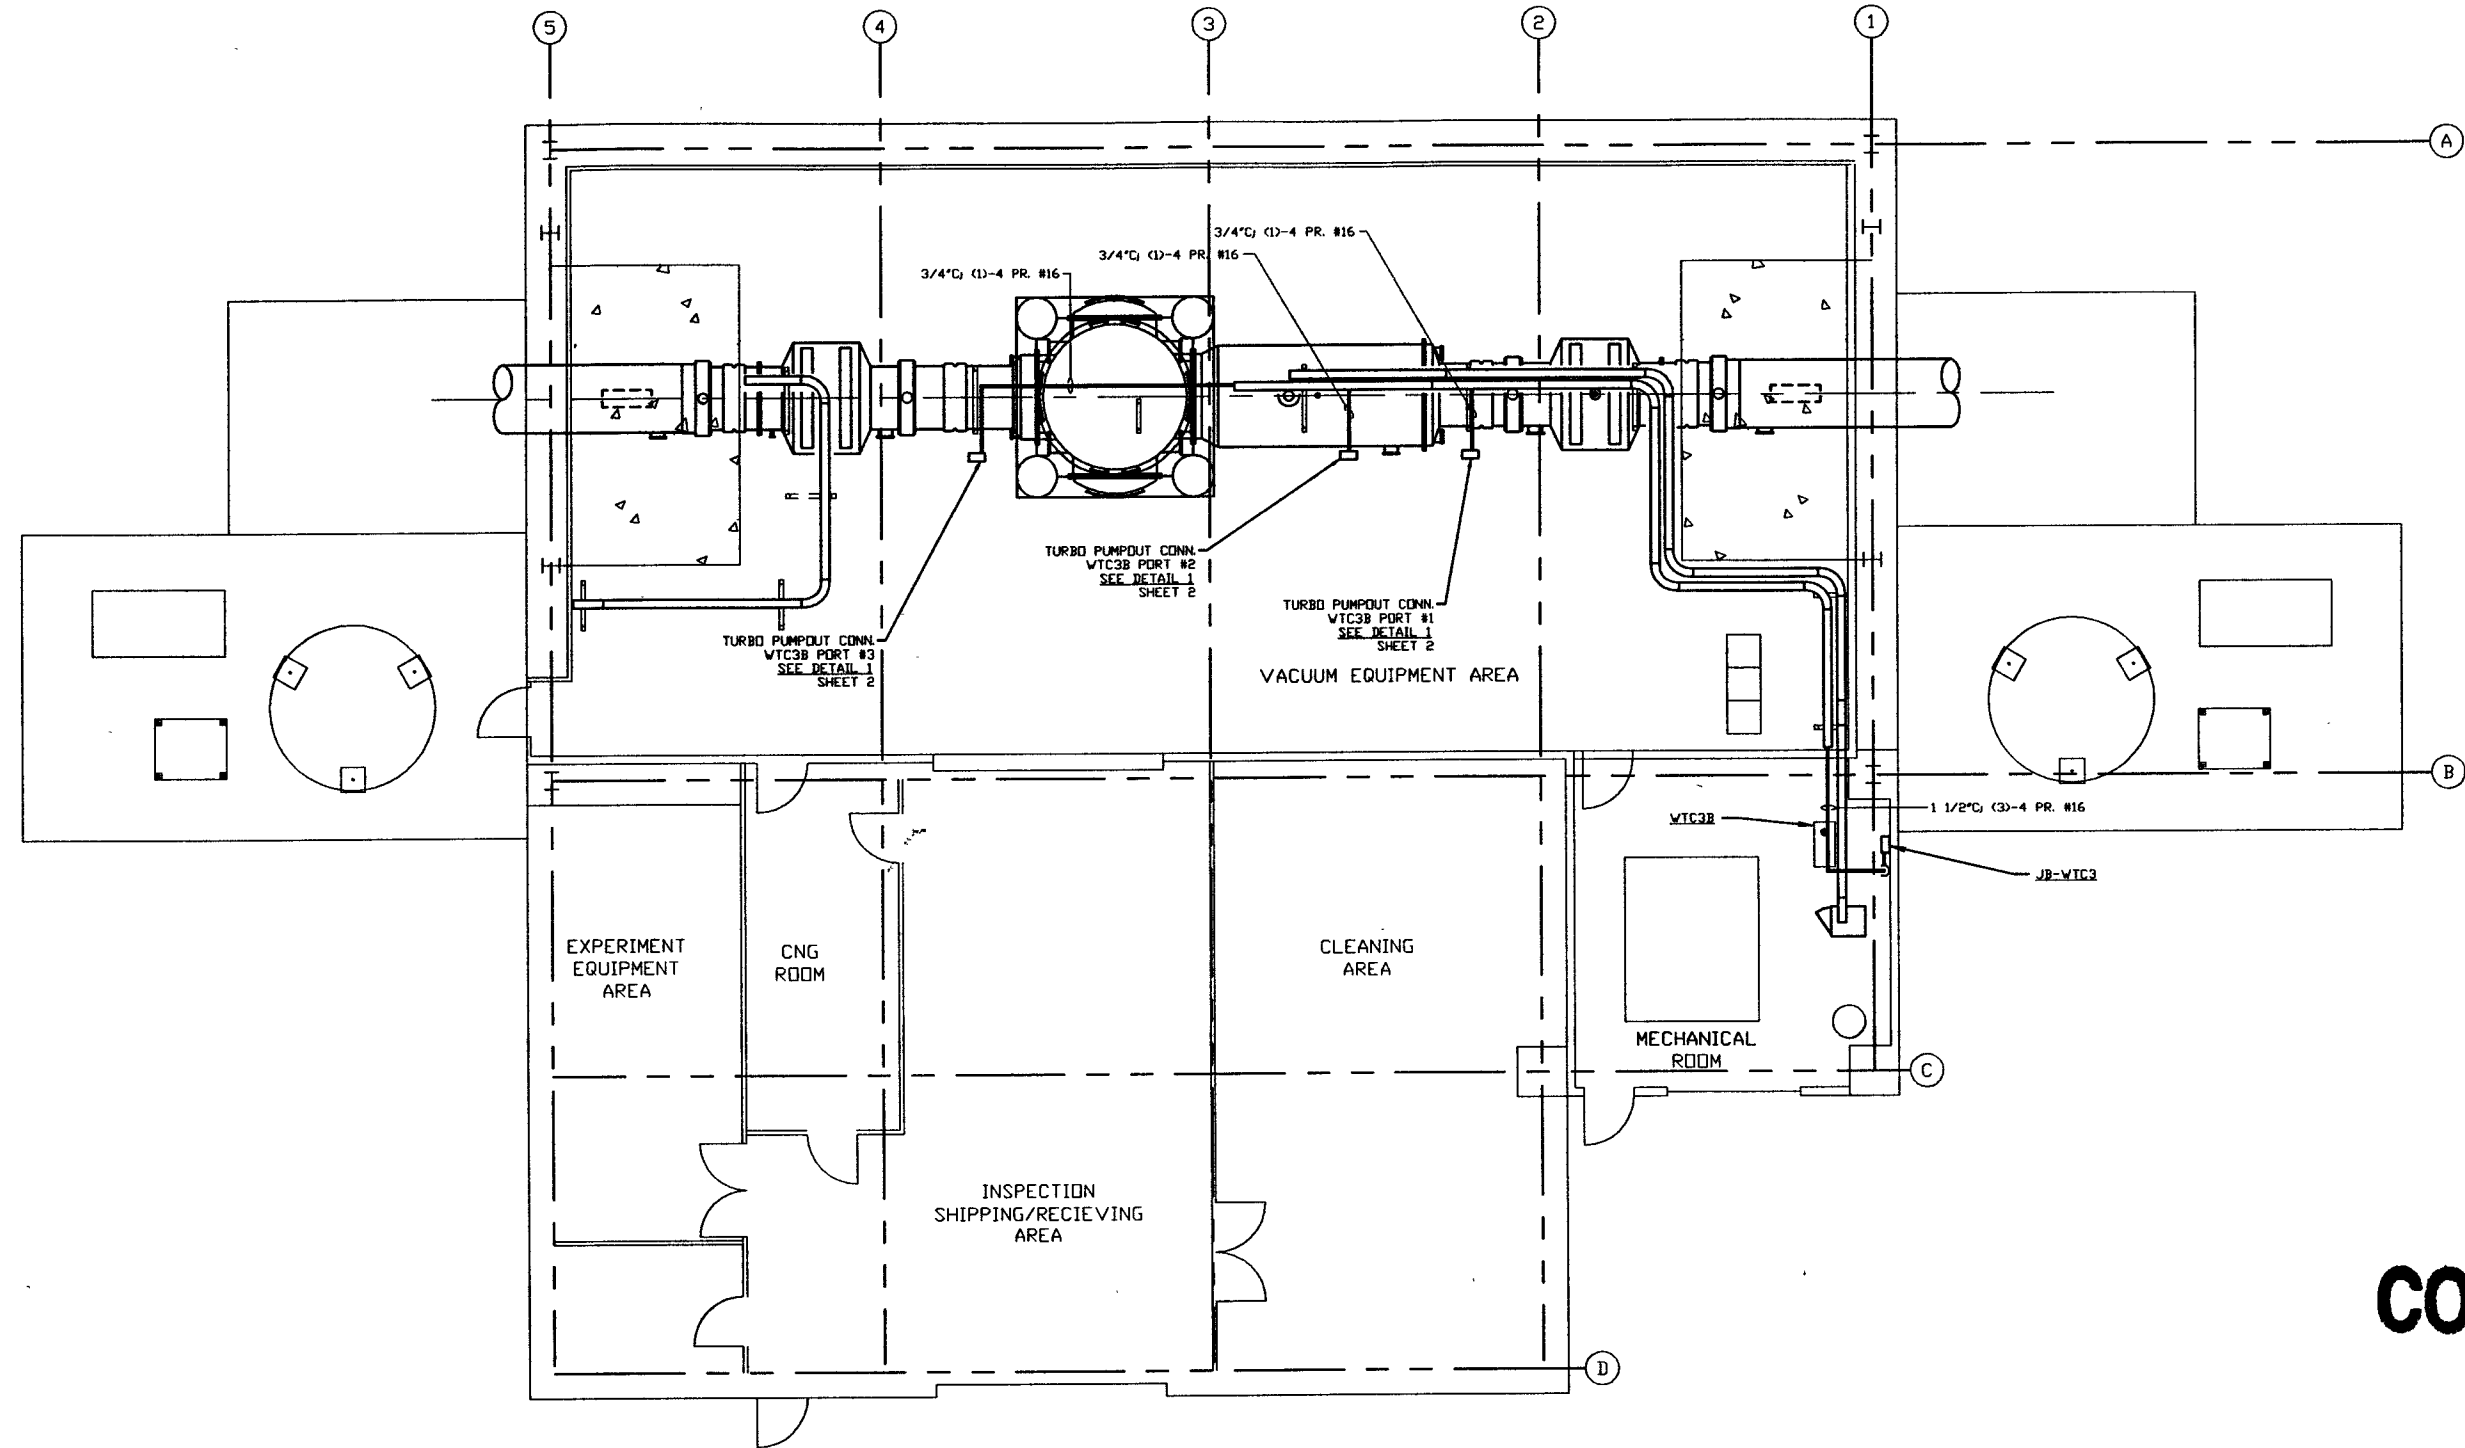

**NOT FOR CONSTRUCTION**

LIGO-D960580-00-V

<p><b>PROPRIETARY AND CONFIDENTIAL</b></p> <p>THIS DOCUMENT CONTAINS PROPRIETARY INFORMATION BELONGING TO PROCESS SYSTEMS INTERNATIONAL, INC. OR ITS AFFILIATED COMPANIES AND SHALL BE USED ONLY FOR THE PURPOSE FOR WHICH IT WAS SUPPLIED. IT SHALL NOT BE COPIED, REPRODUCED OR OTHERWISE USED, NOR SHALL SUCH INFORMATION BE FURNISHED IN WHOLE OR IN PART TO OTHERS EXCEPT IN ACCORDANCE WITH THE TERMS OF ANY AGREEMENT UNDER WHICH IT WAS SUPPLIED BY WITH THE PRIOR WRITTEN CONSENT OF PROCESS SYSTEMS INTERNATIONAL, INC. AND SHALL BE RETURNED UPON REQUEST.</p>			<p>UNLESS OTHERWISE SPECIFIED DIMENSIONS ARE IN INCHES</p> <p>FRACTIONAL &amp; ANGULAR DIMENSIONS 1/16"-20" RISE 1/8" &amp; 1/4" TWO PLACE DECIMAL &amp; ALL FINISHED SURFACE DIMENSIONS SHALL BE TO BREAK CORNERS TO REMOVE ALL BURRS</p>			<p>PROCESS SYSTEMS INTERNATIONAL, INC. 20 WALKUP DR. WESTBOROUGH, MASSACHUSETTS 01581 USA</p>		
<p>V049-3-202 CABLE TRAY PLAN LEFT MID STATION</p> <p>V049-3-002 OVERALL SITE PLAN WASHINGTON</p> <p>V049-3-001 GENERAL NOTES, LEGEND &amp; DRAWING LIST</p>			<p>DO NOT SCALE THIS DRAWING</p> <p>USED ON: _____</p> <p>NEXT ASS'Y: _____</p>			<p>VACUUM CART INTERFACE PLAN LIGO VACUUM EQUIPMENT WASHINGTON SITE LEFT MID STATION</p>		
<p>REFERENCE DRAWINGS</p>			<p>ISSUE DESCRIPTION</p>			<p>CAD FILE: V0493206/3206S1 REV: D SCALE: 3/16" = 1' - 0"</p>		
<p>DWG. NO. DESCRIPTION</p>			<p>REV DESCRIPTION</p>			<p>CHKD: <i>DLW</i> DATE: 04.26.96 BY: <i>DLW</i> DATE: 0129</p>		
<p>1</p>			<p>2</p>			<p>3</p>		
<p>4</p>			<p>5</p>			<p>6</p>		
<p>7</p>			<p>8</p>			<p>9</p>		

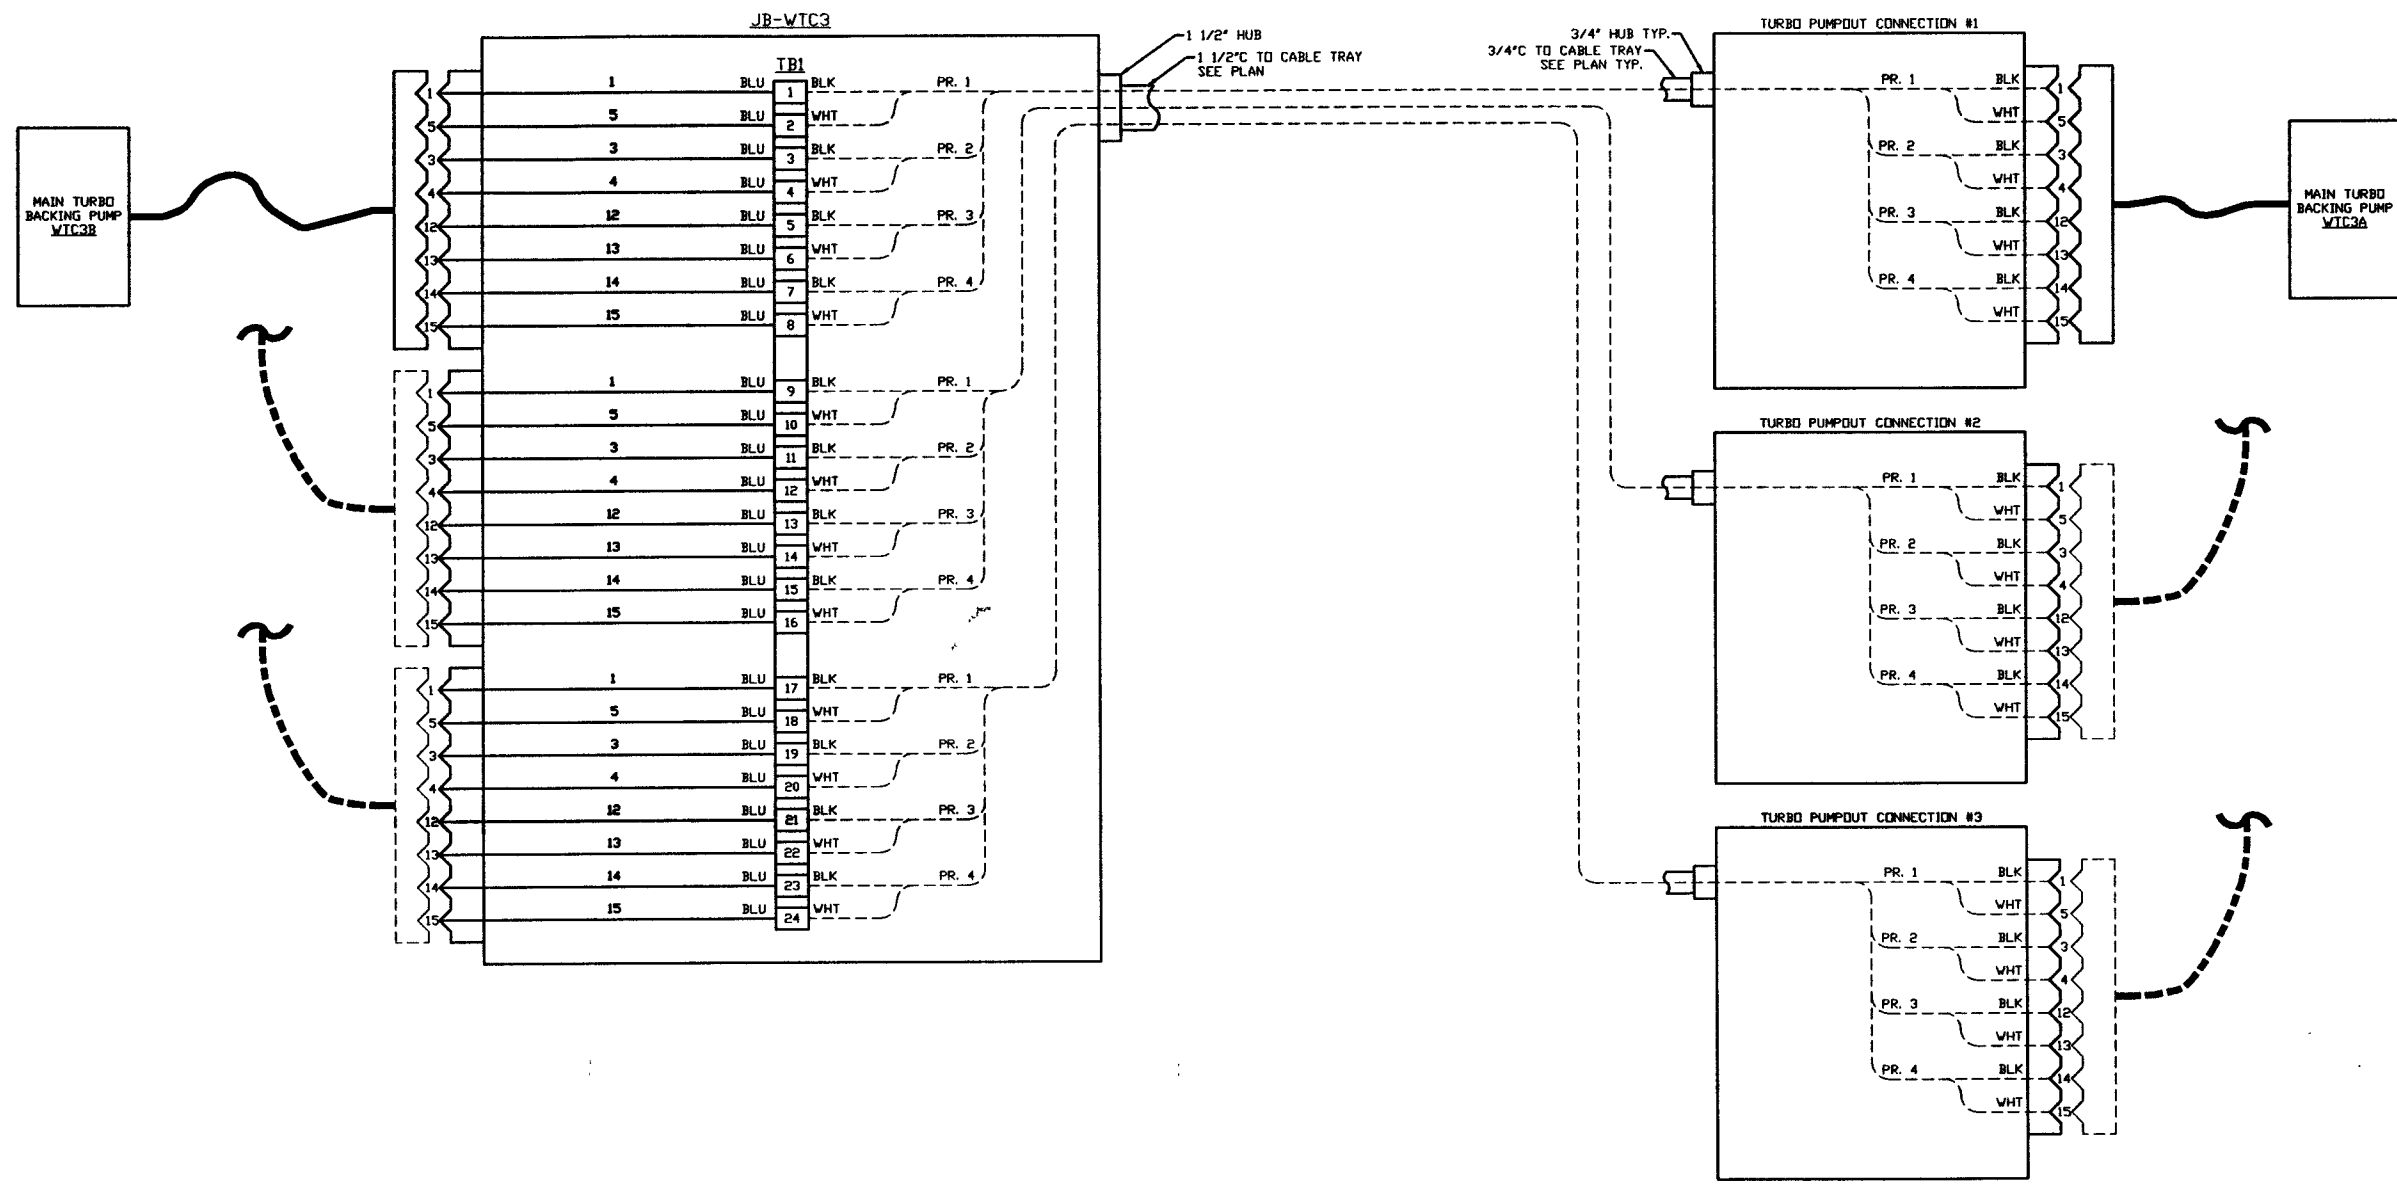

**NOT FOR  
CONSTRUCTION**

**DETAIL 1**  
MAIN TURBO CART INTERFACE WIRING DIAGRAM  
NO SCALE

SEE SHEET 1 FOR REVISIONS

<b>PROCESS SYSTEMS INTERNATIONAL INC.</b> <small>20 WALSH DR. WESTBOROUGH, MASSACHUSETTS 01581 USA</small>			
<b>VACUUM CARTS INTERFACE PLAN</b> <b>LIGO VACUUM EQUIPMENT</b> <b>WASHINGTON SITE</b> <b>LEFT MID STATION</b>			
CAD FILE	SIZE	DWG NO.	REV.
V0493206\3206S2	D	V049-3-206	0
SCALE	NONE	SHEET	2 OF 2

8 7 6 5 4 3 2 1