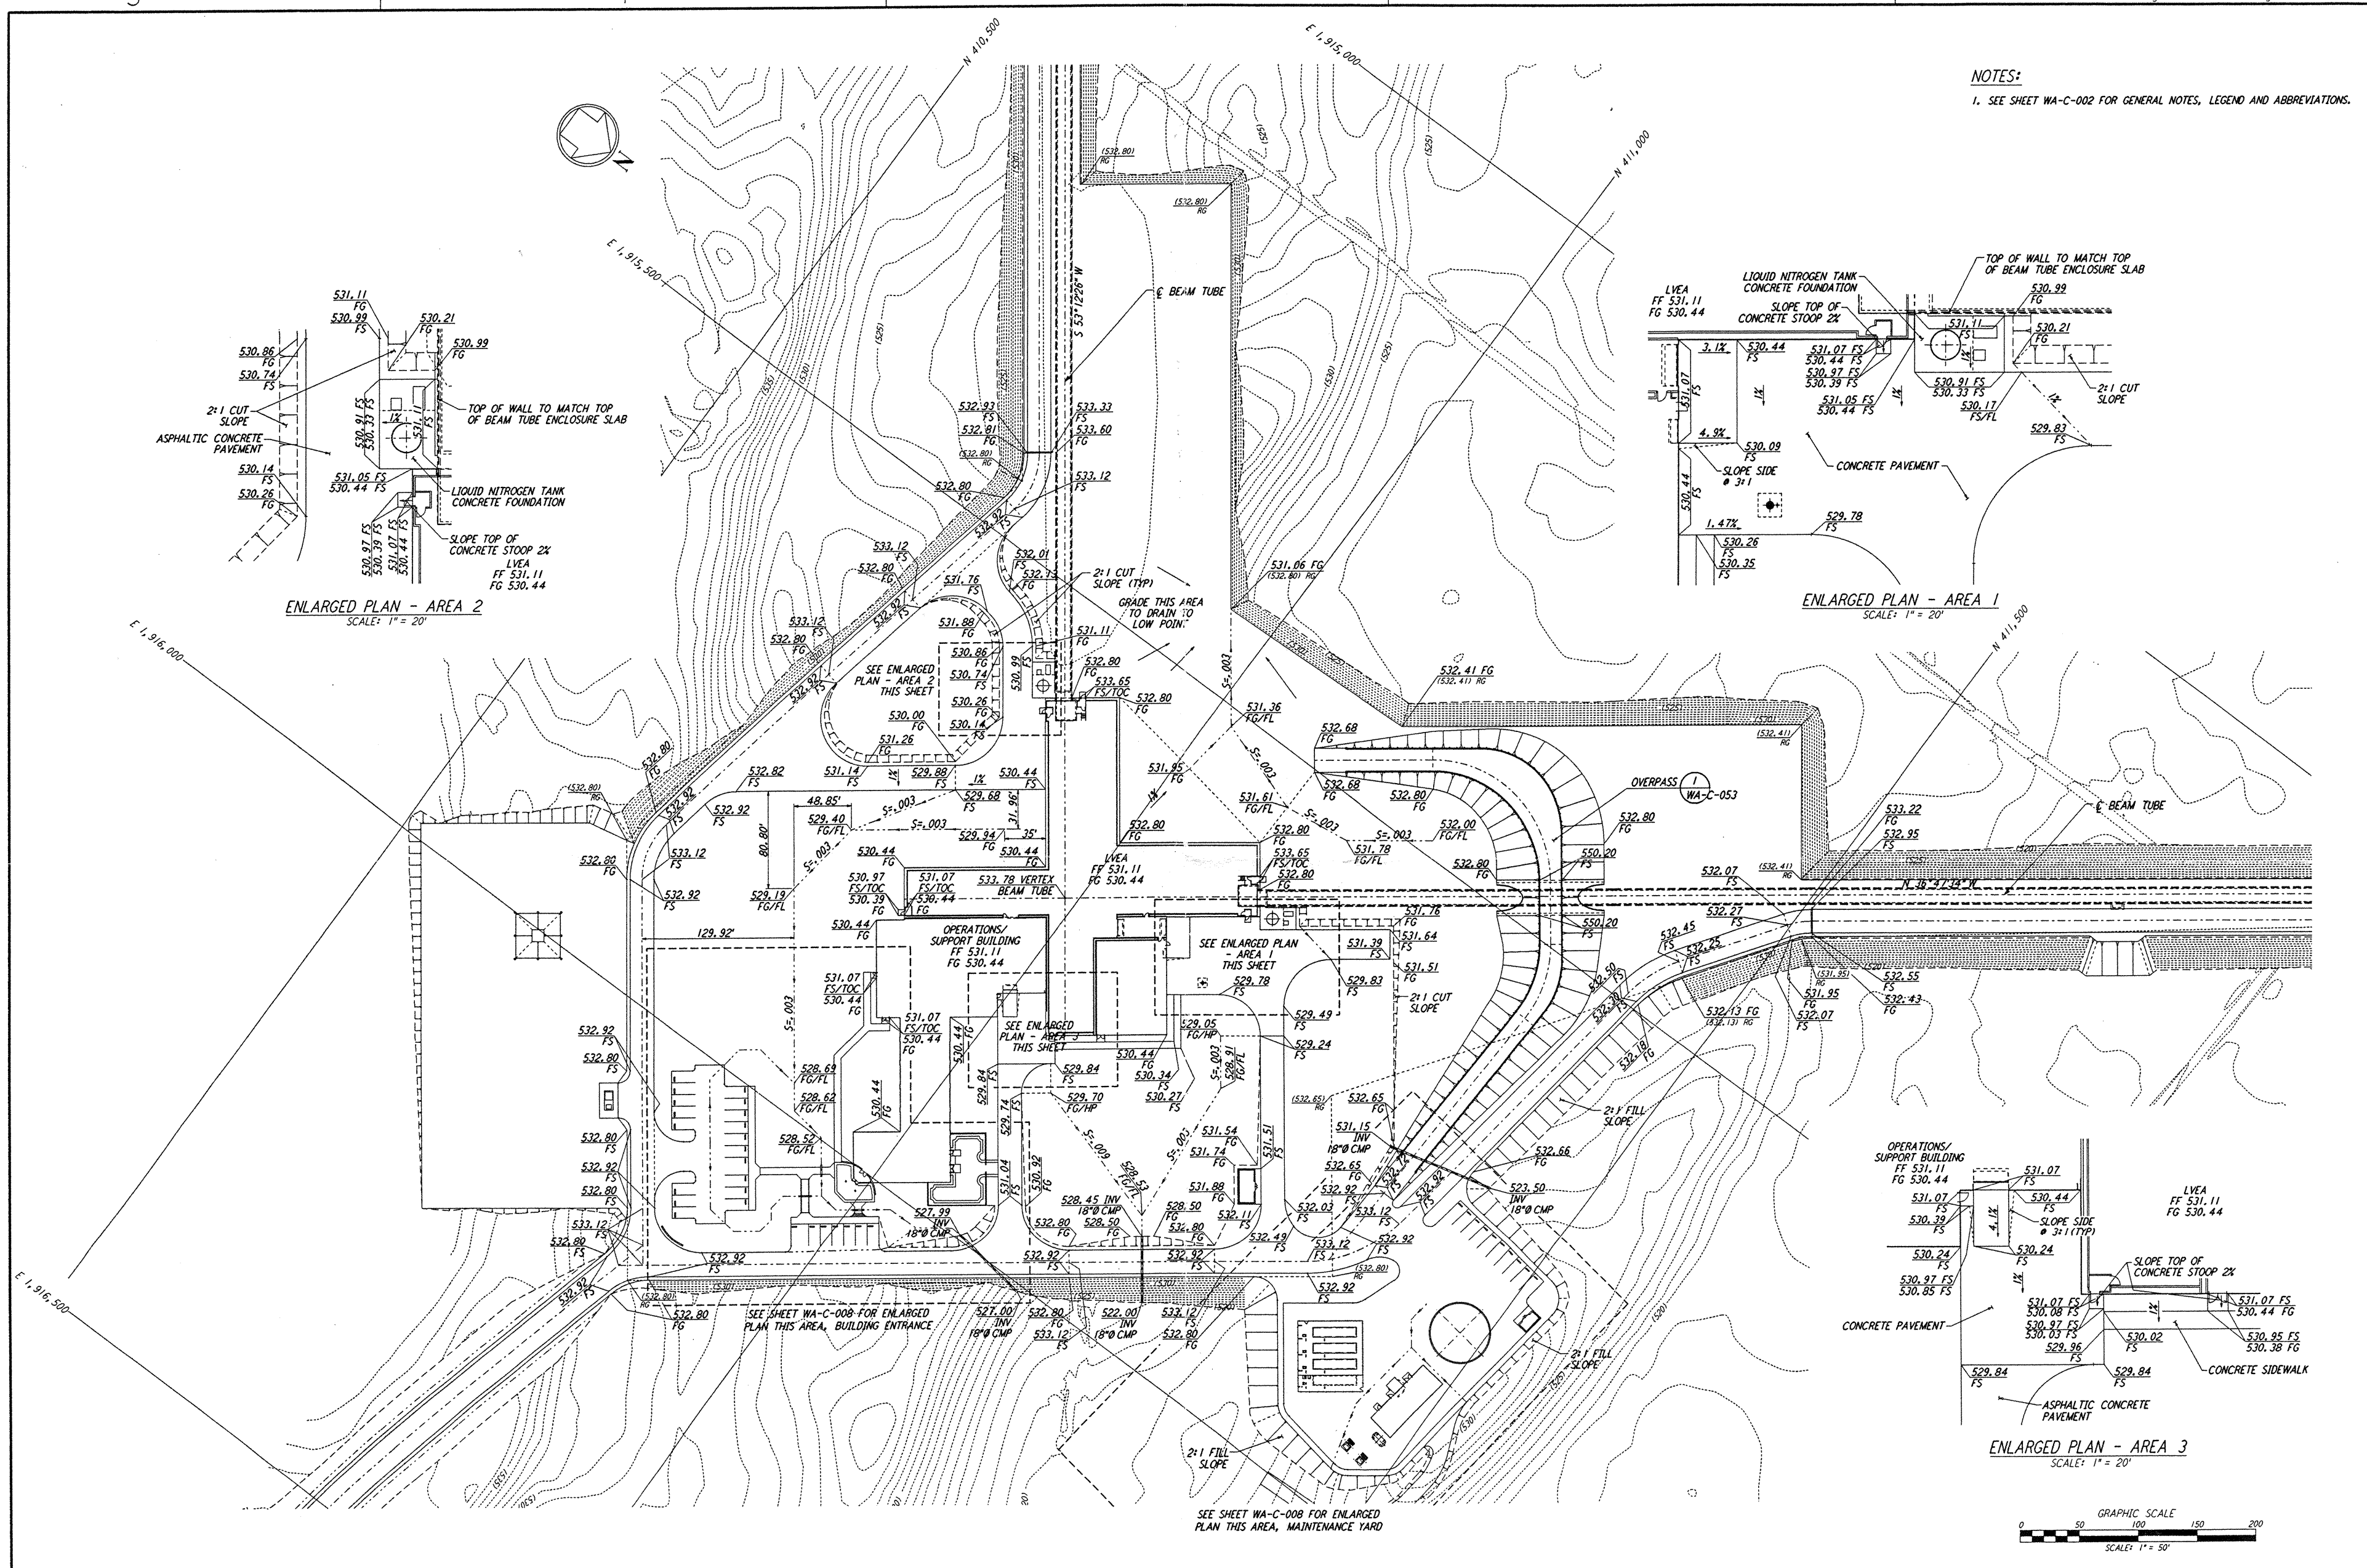


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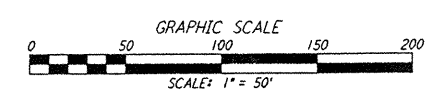


**NOTES:**  
 1. SEE SHEET WA-C-002 FOR GENERAL NOTES, LEGEND AND ABBREVIATIONS.

**ENLARGED PLAN - AREA 2**  
 SCALE: 1" = 20'

**ENLARGED PLAN - AREA 1**  
 SCALE: 1" = 20'

**ENLARGED PLAN - AREA 3**  
 SCALE: 1" = 20'



NO.	DATE	BY	CHKD	ENGR	PROJ	DESCRIPTION
B	4/19/96	WRB	MM	CP		FINAL DESIGN REVIEW
A	10/31/95	WRB	TOM			PRELIMINARY DESIGN REVIEW

DRAWN	WRB
CHECKED	
ENGINEER	
PROJ	

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 100 WEST WALNUT STREET  
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LASER INTERFEROMETER  
 GRAVITATIONAL-WAVE OBSERVATORY  
 SITE NO. 1 - HANFORD, WASHINGTON

TITLE	CIVIL CORNER STATION GRADING PLAN	SCALE	1" = 50'	CONTRACT NUMBER	PP150969	PROJECT NUMBER	8094
SHEET NUMBER	WA-C-007	PERMISSIONS					