



NOTE:
 1. PROVIDE SIGNS AT ALL WATER OUTLETS
 IN THE MID AND END STATIONS STATING
 "NOT DRINKING WATER"

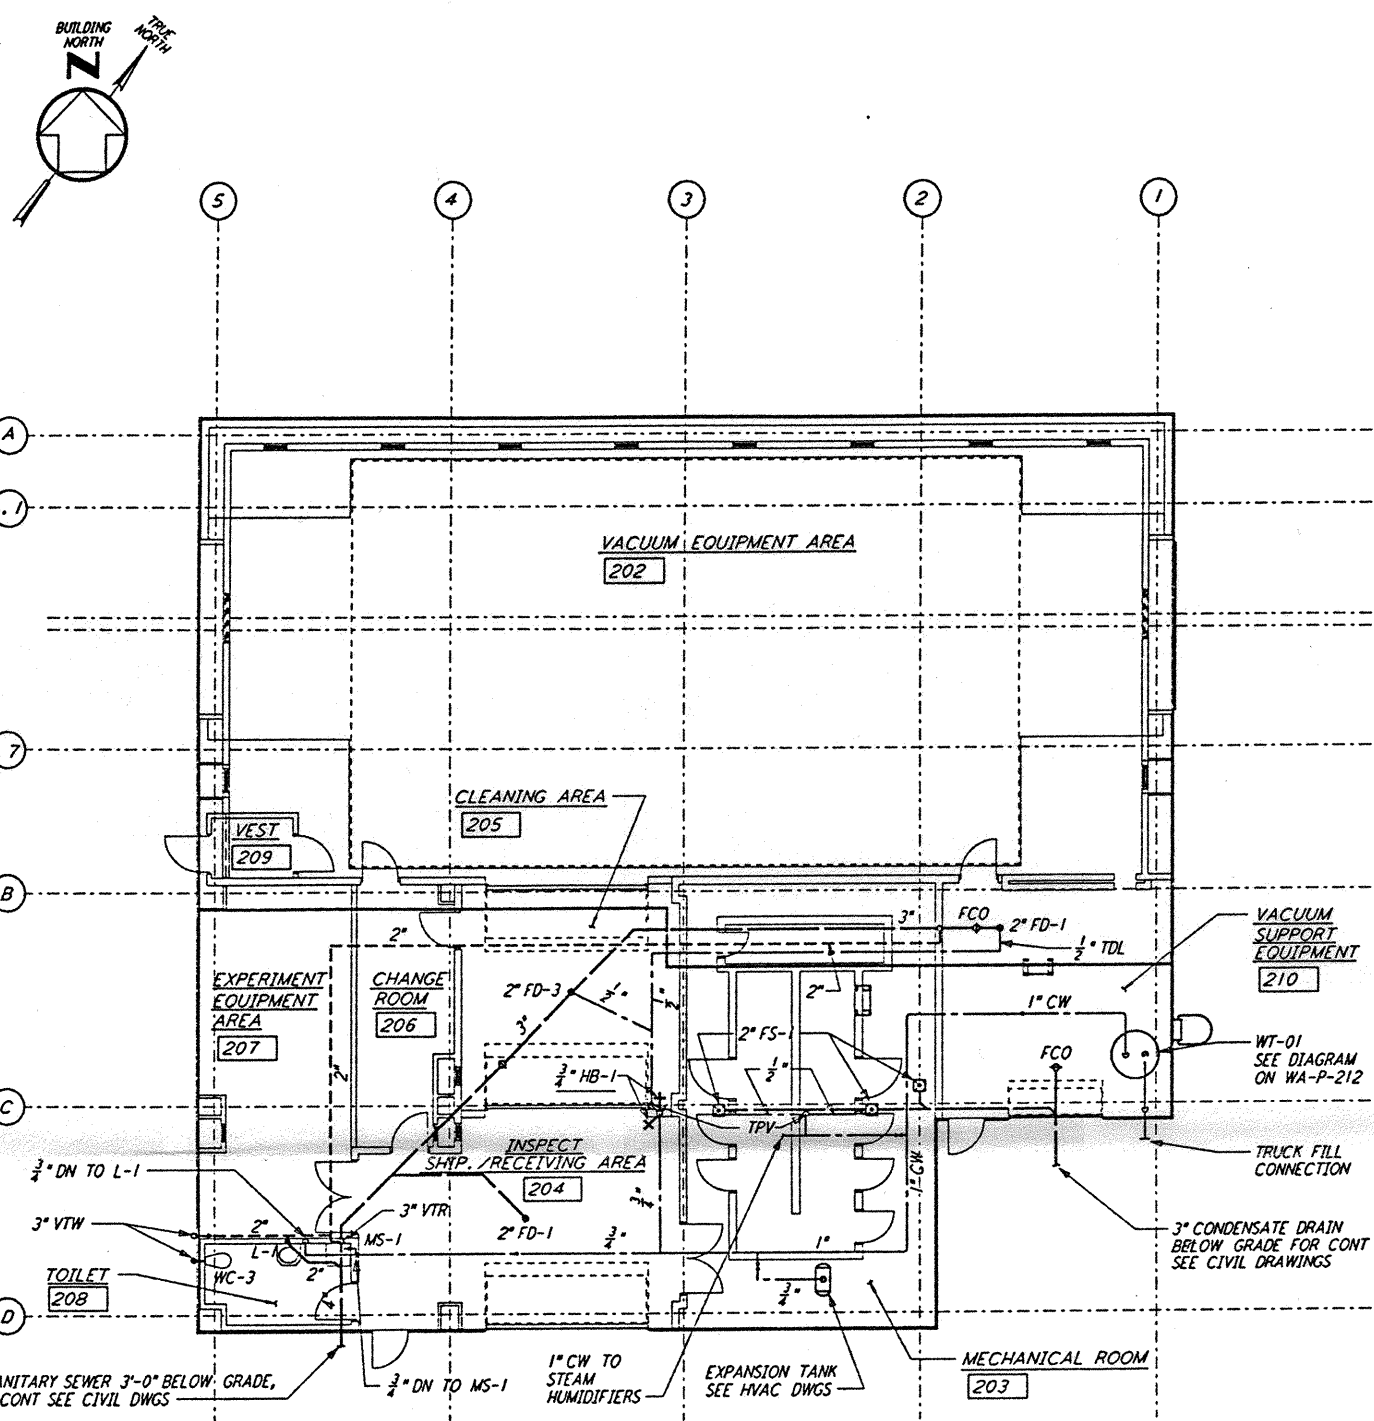


**NOTE: OMIT ALL UNDERGROUND
 WORK FROM THIS PACKAGE**

MID & END STATION "B" FLOOR PLAN
 1/8" = 1'-0"

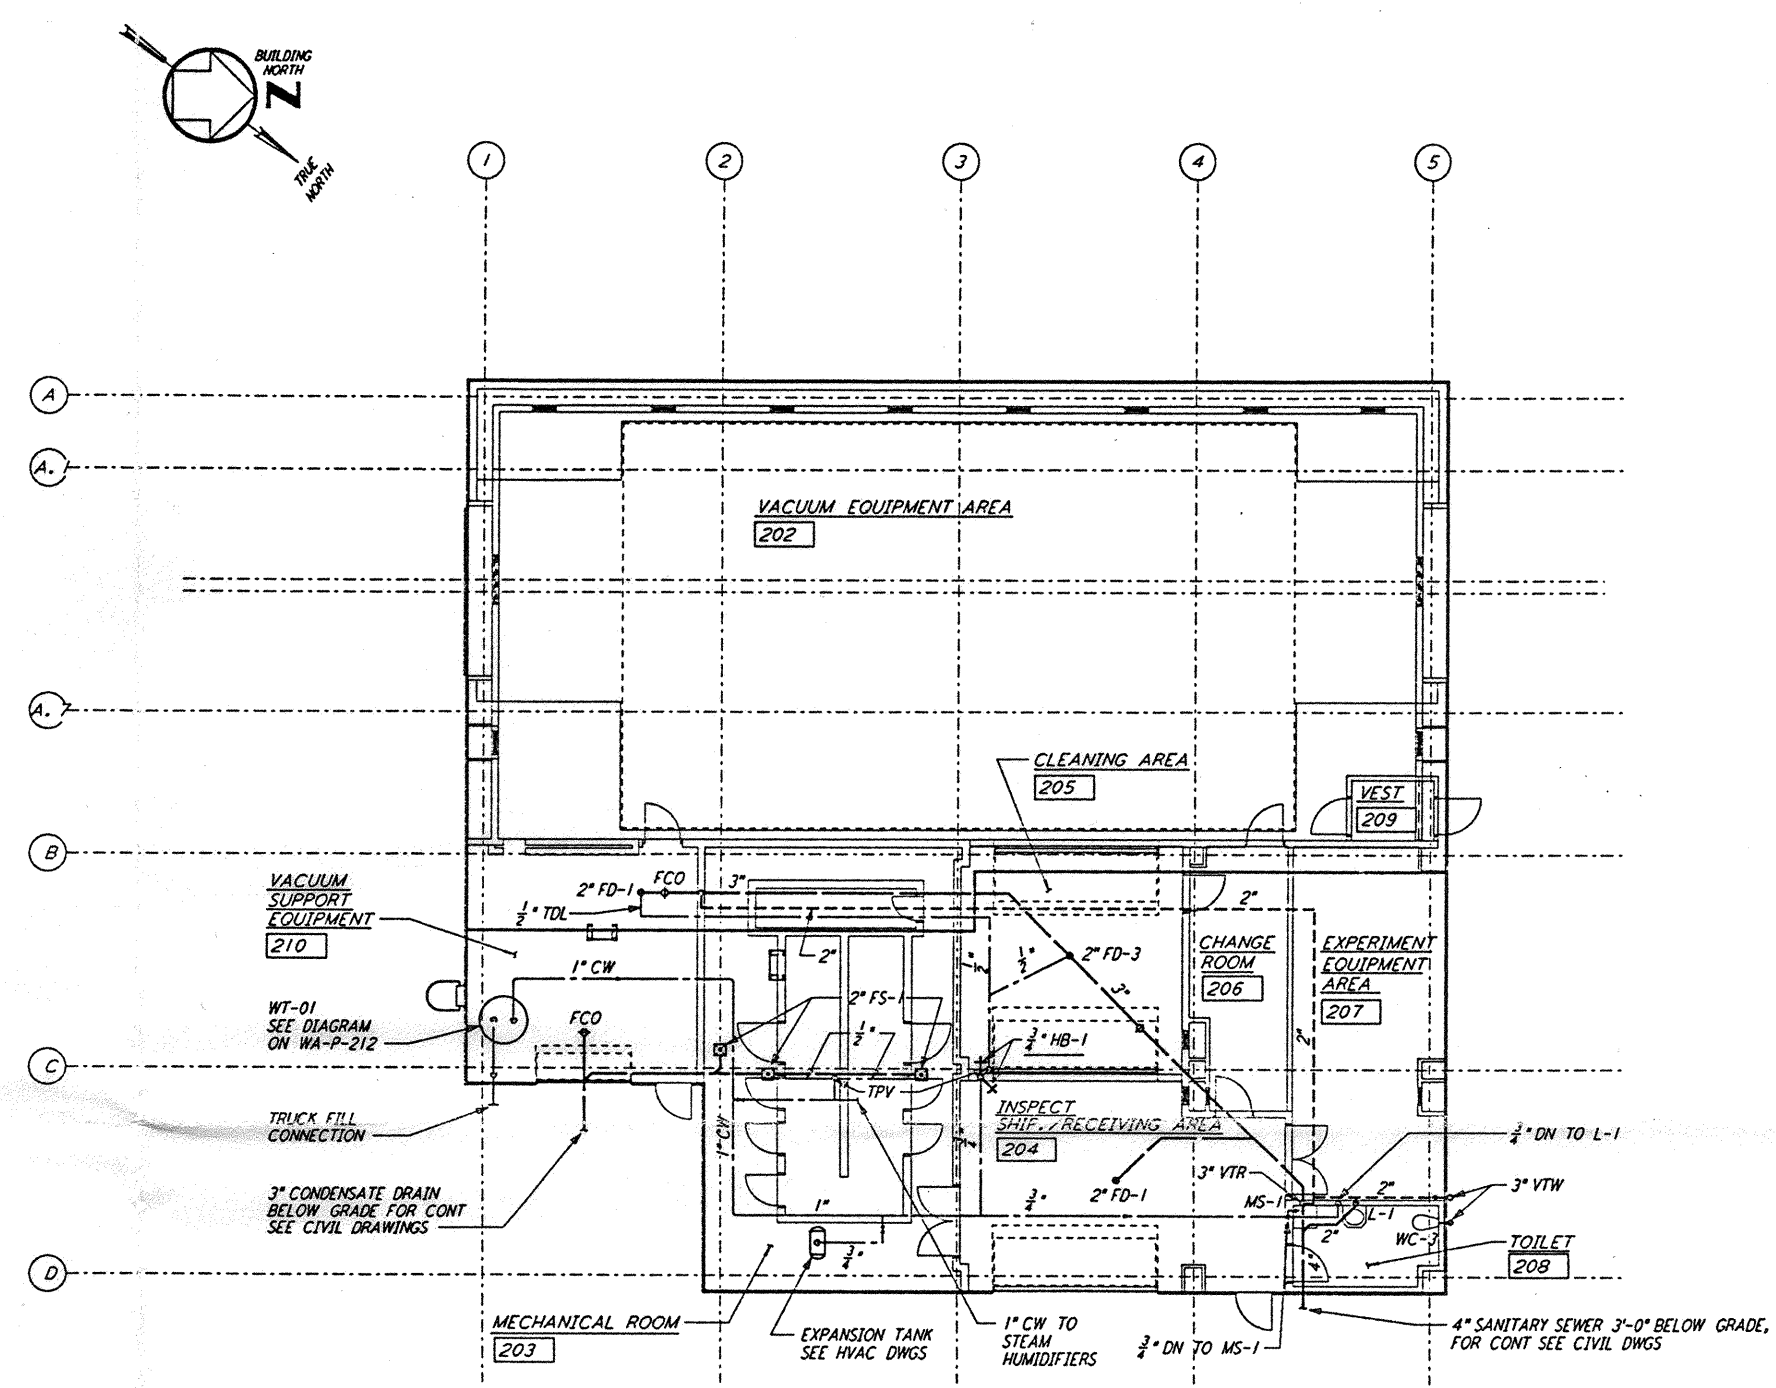

MID & END STATION "A" FLOOR PLAN
 1/8" = 1'-0"

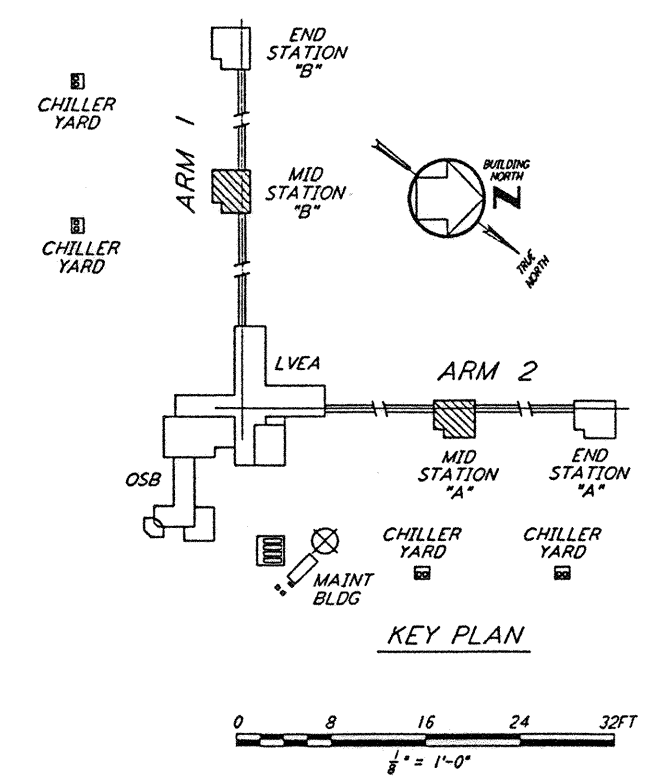

KEY PLAN

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NO.	DATE	BY	CHKD	ENGR	PROJ	DESCRIPTION
B	4-19-96	DG	MP	MN	TOM	FINAL DESIGN REVIEW & BID
A	10-31-95	SG	MP	MN	TOM	PRELIMINARY DESIGN REVIEW

DRAWN	DC
CHECKED	
ENGINEER	
PROJ	

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LIGO
 CALIFORNIA INSTITUTE OF TECHNOLOGY
 MASSACHUSETTS INSTITUTE OF TECHNOLOGY

LASER INTERFEROMETER
 GRAVITATIONAL-WAVE OBSERVATORY
 SITE NO. 1 - HANFORD, WASHINGTON

TITLE: PLUMBING
 MID & END STATIONS
 FLOOR PLAN

SCALE: AS NOTED
 CONTRACT NUMBER: PPI50969
 PROJECT NUMBER: 8094

SHEET NUMBER: **WA-P-211**