



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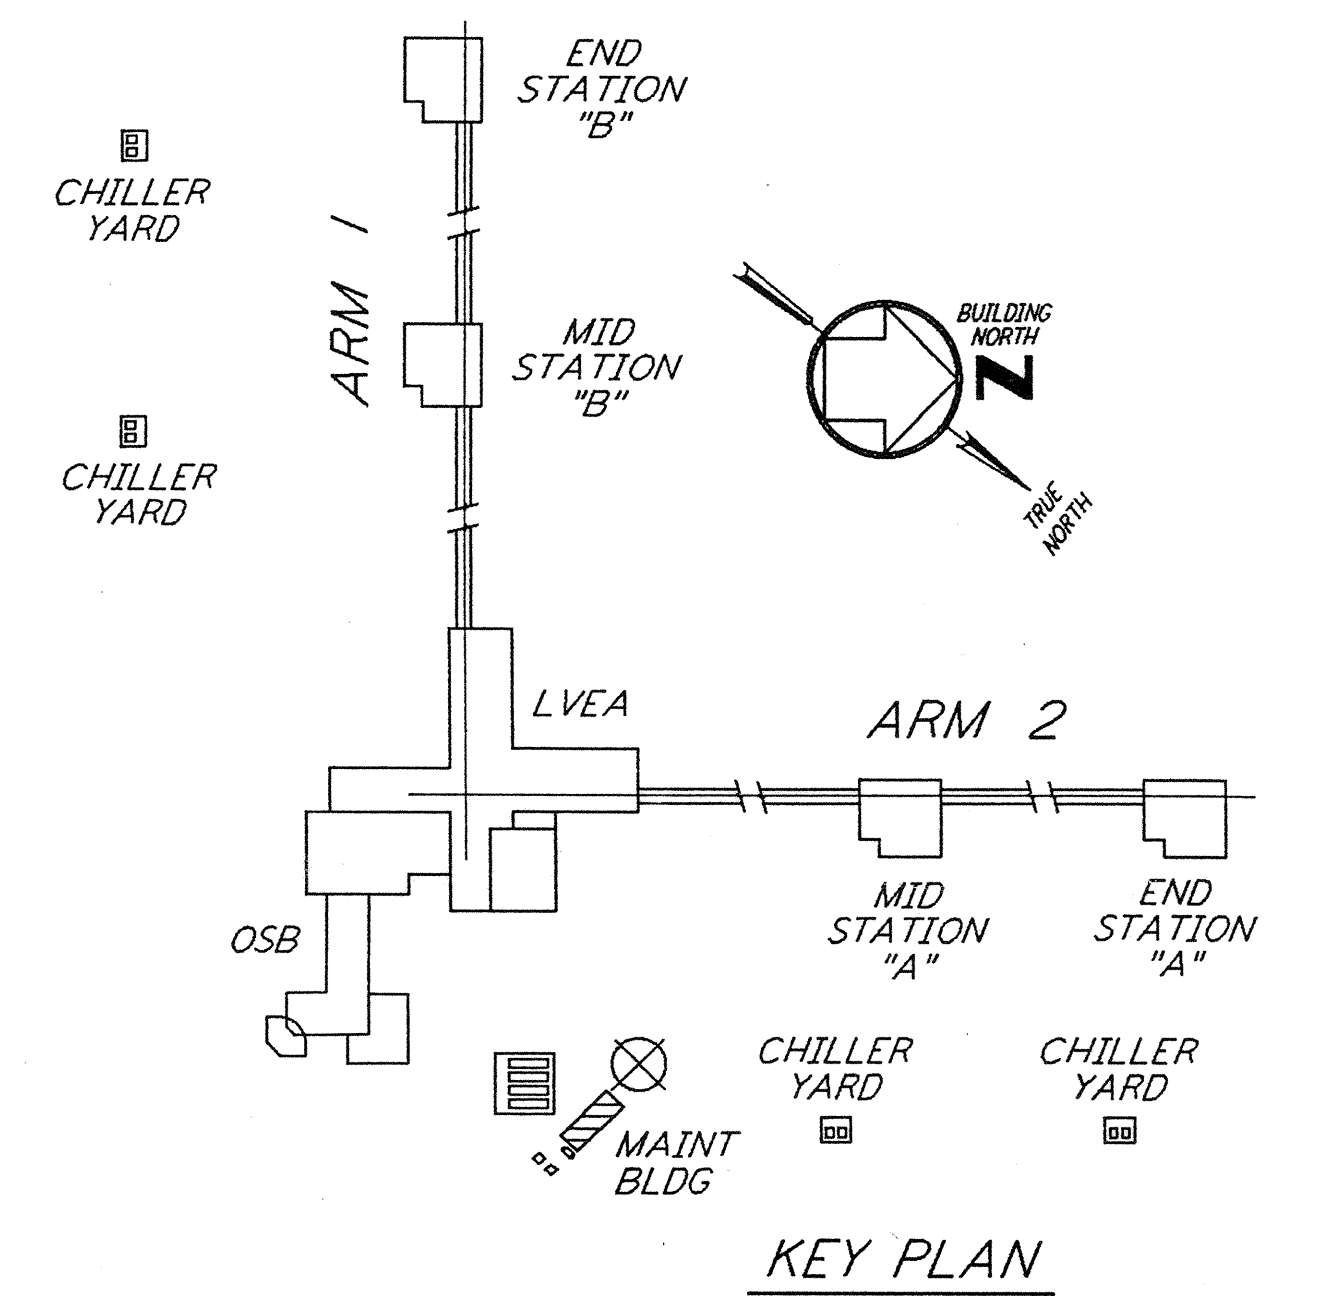


MAINTENANCE BLDG. FLOOR PLAN
 1/4" = 1'-0"

NOTE:
 1. ALL EXTERIOR PIPING SHALL BE HEAT TRACED AND INSULATED.

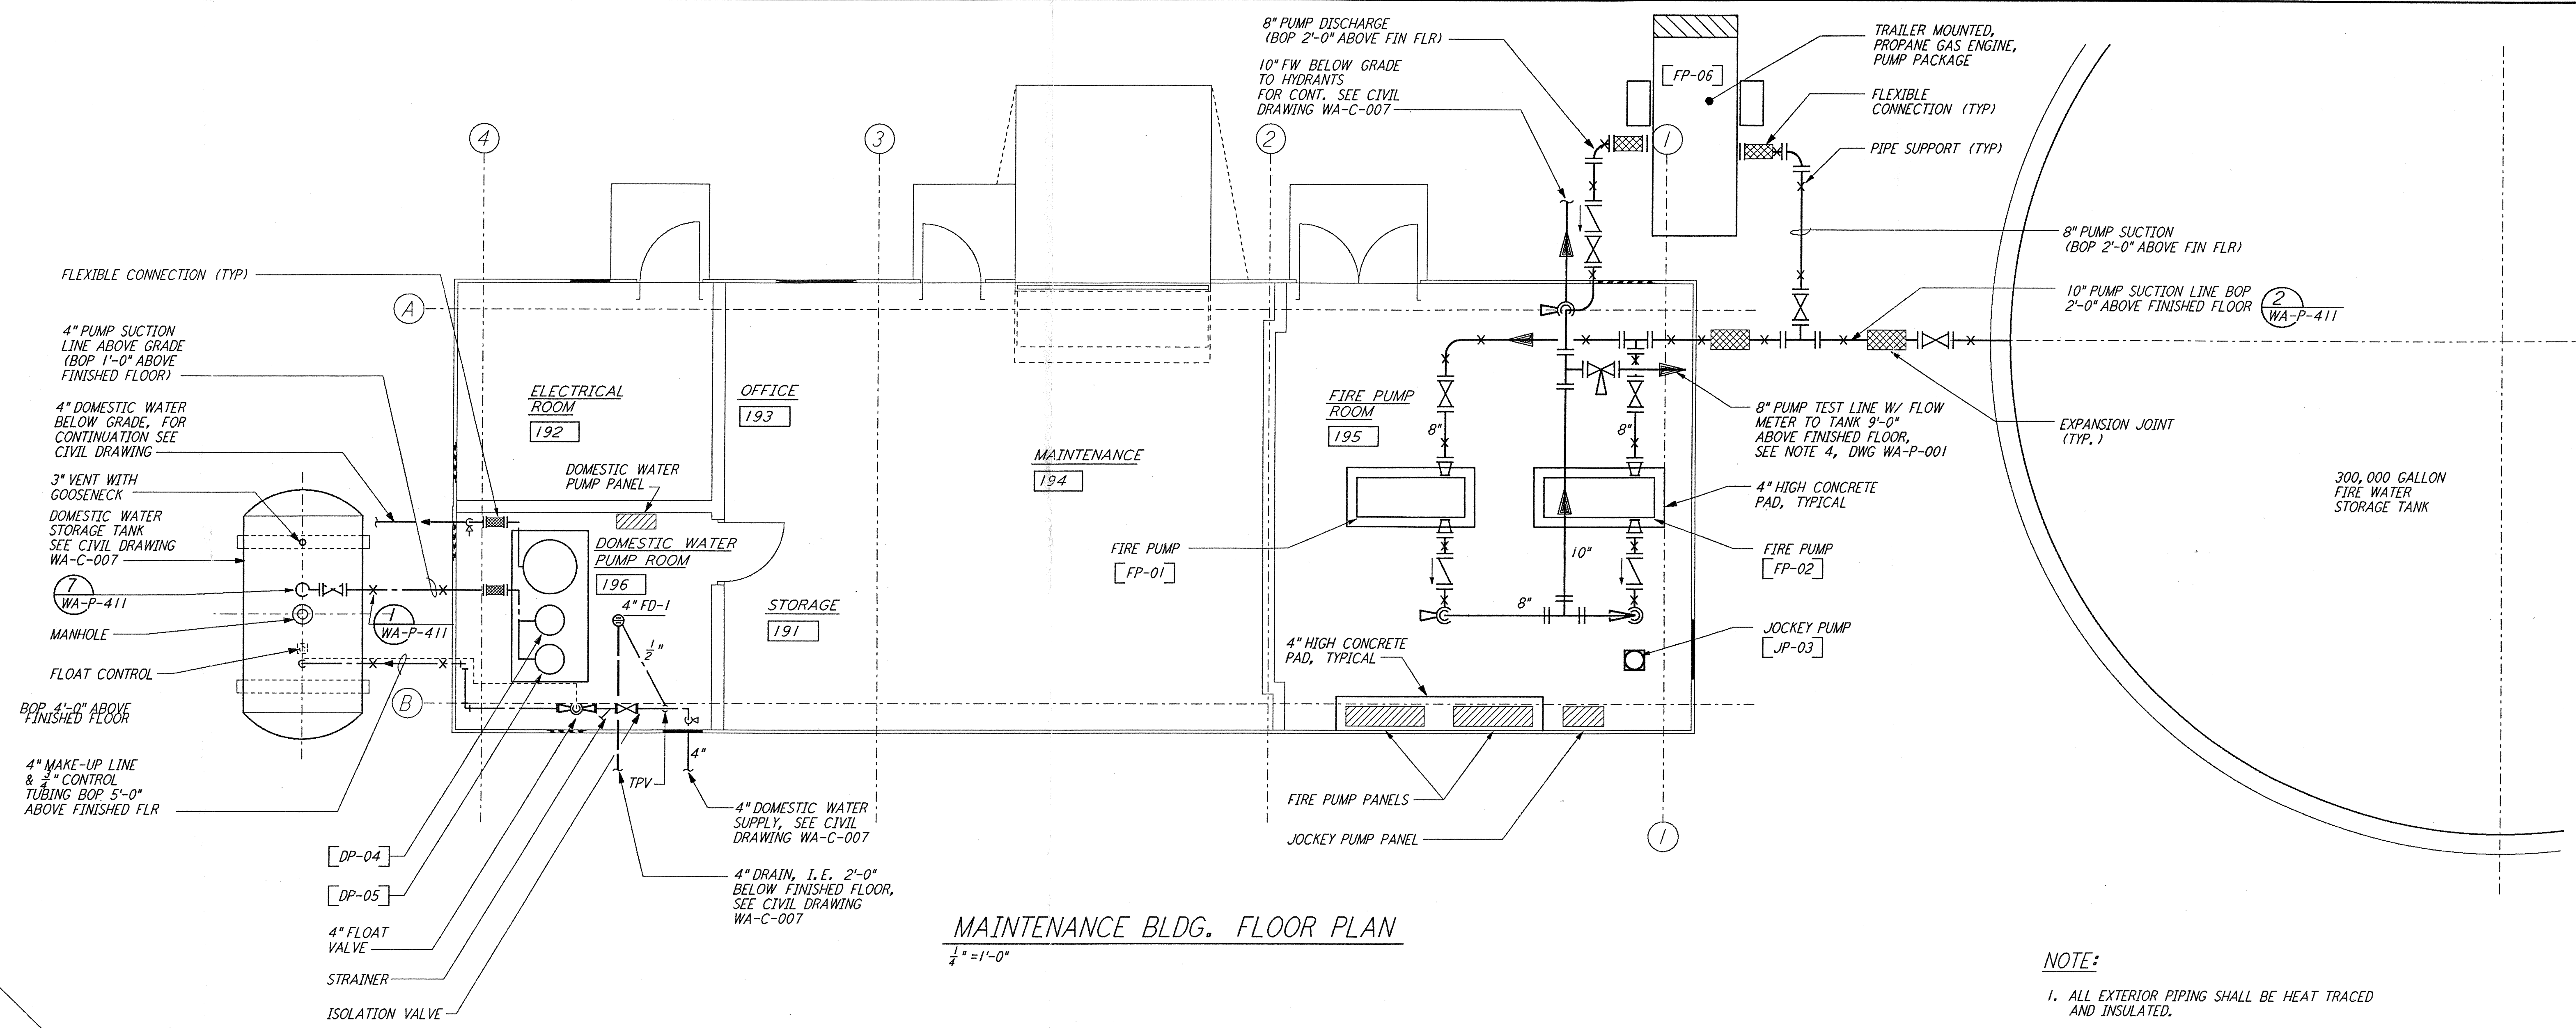

FIRE PUMP FLOW DIAGRAM
 SCALE: NTS

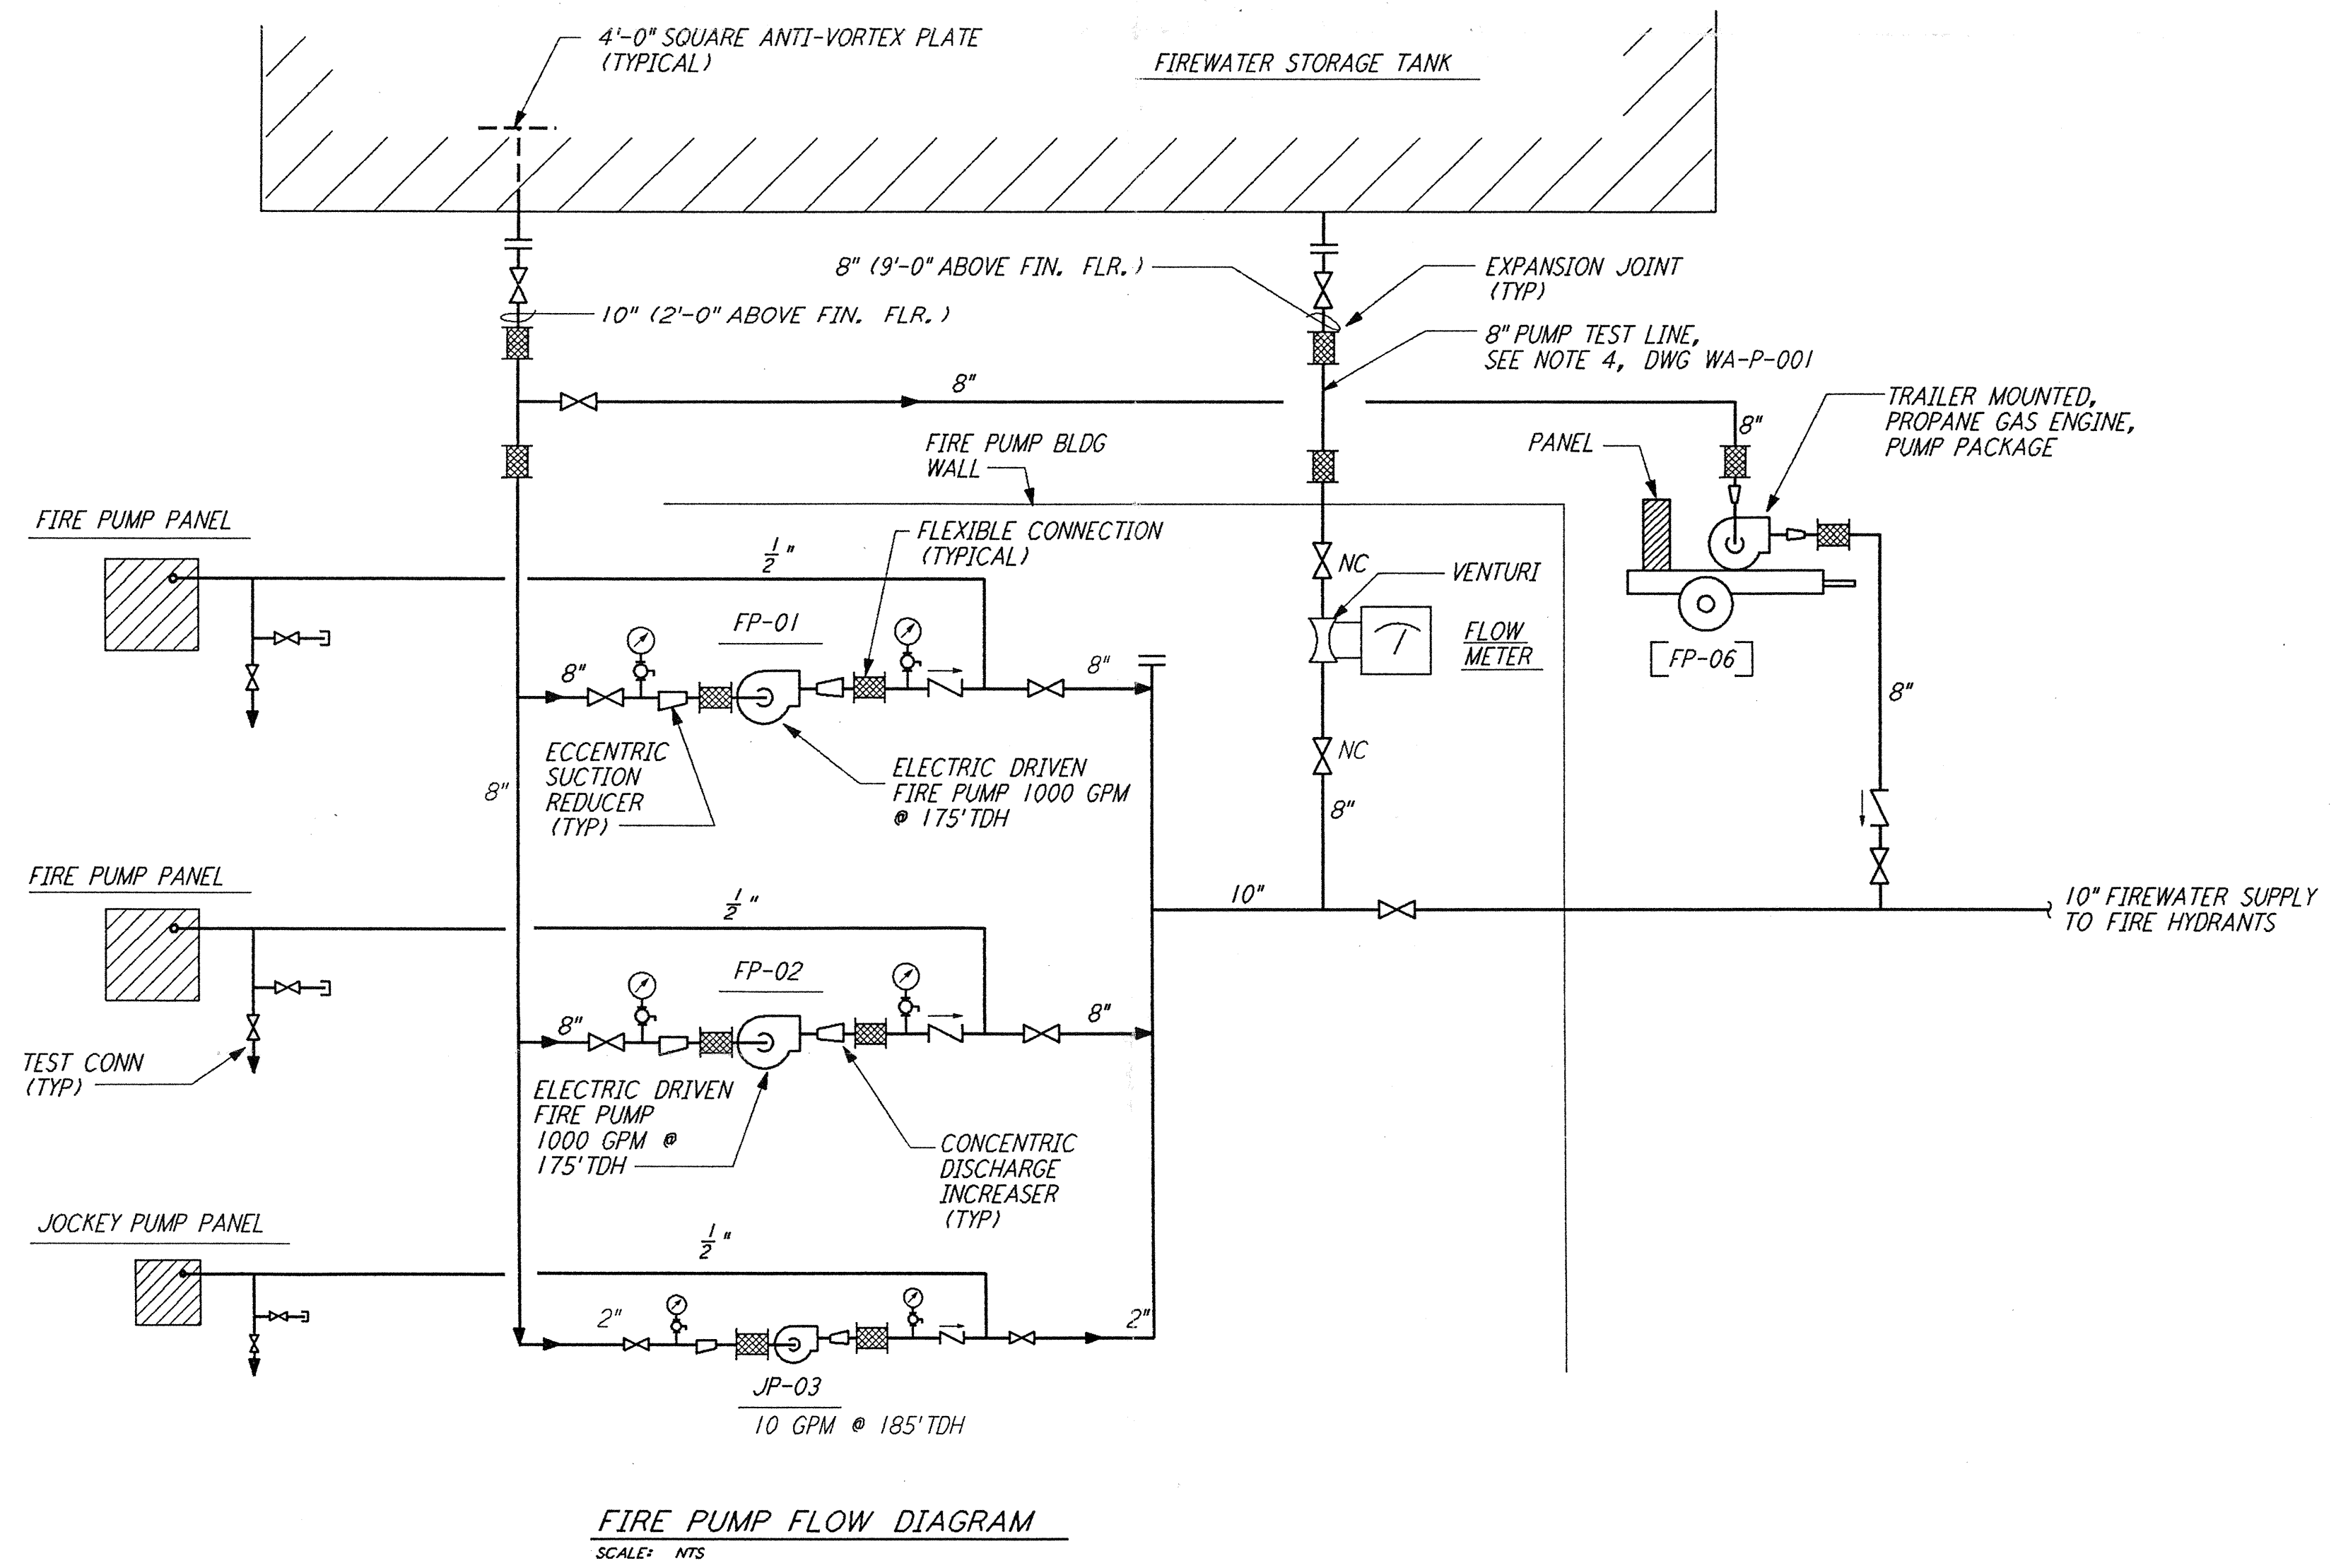

KEY PLAN
 1/4" = 1'-0"

NO.	DATE	BY	CHKD	ENGR	PROJ	DESCRIPTION
B	4-19-96	DG	MP	MN		FINAL DESIGN REVIEW & BID
A	10-31-95	SG	MP	MN	TDM	PRELIMINARY DESIGN REVIEW

DRAWN	DG
CHECKED	
ENGINEER	
PROJ	

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 PASADENA, CALIFORNIA

LIGO
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 MASSACHUSETTS INSTITUTE OF TECHNOLOGY

LASER INTERFEROMETER
 GRAVITATIONAL-WAVE OBSERVATORY
 SITE NO. 1 - HANFORD, WASHINGTON

TITLE	PLUMBING CORNER STATION MAINTENANCE BUILDING FLOOR PLAN & FLOW DIAGRAM	SCALE	AS NOTED	CONTRACT NUMBER	PP150969	PROJECT NUMBER	8094
DRAWING NO.		SHEET NUMBER		WA-P-113		REVISIONS	

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