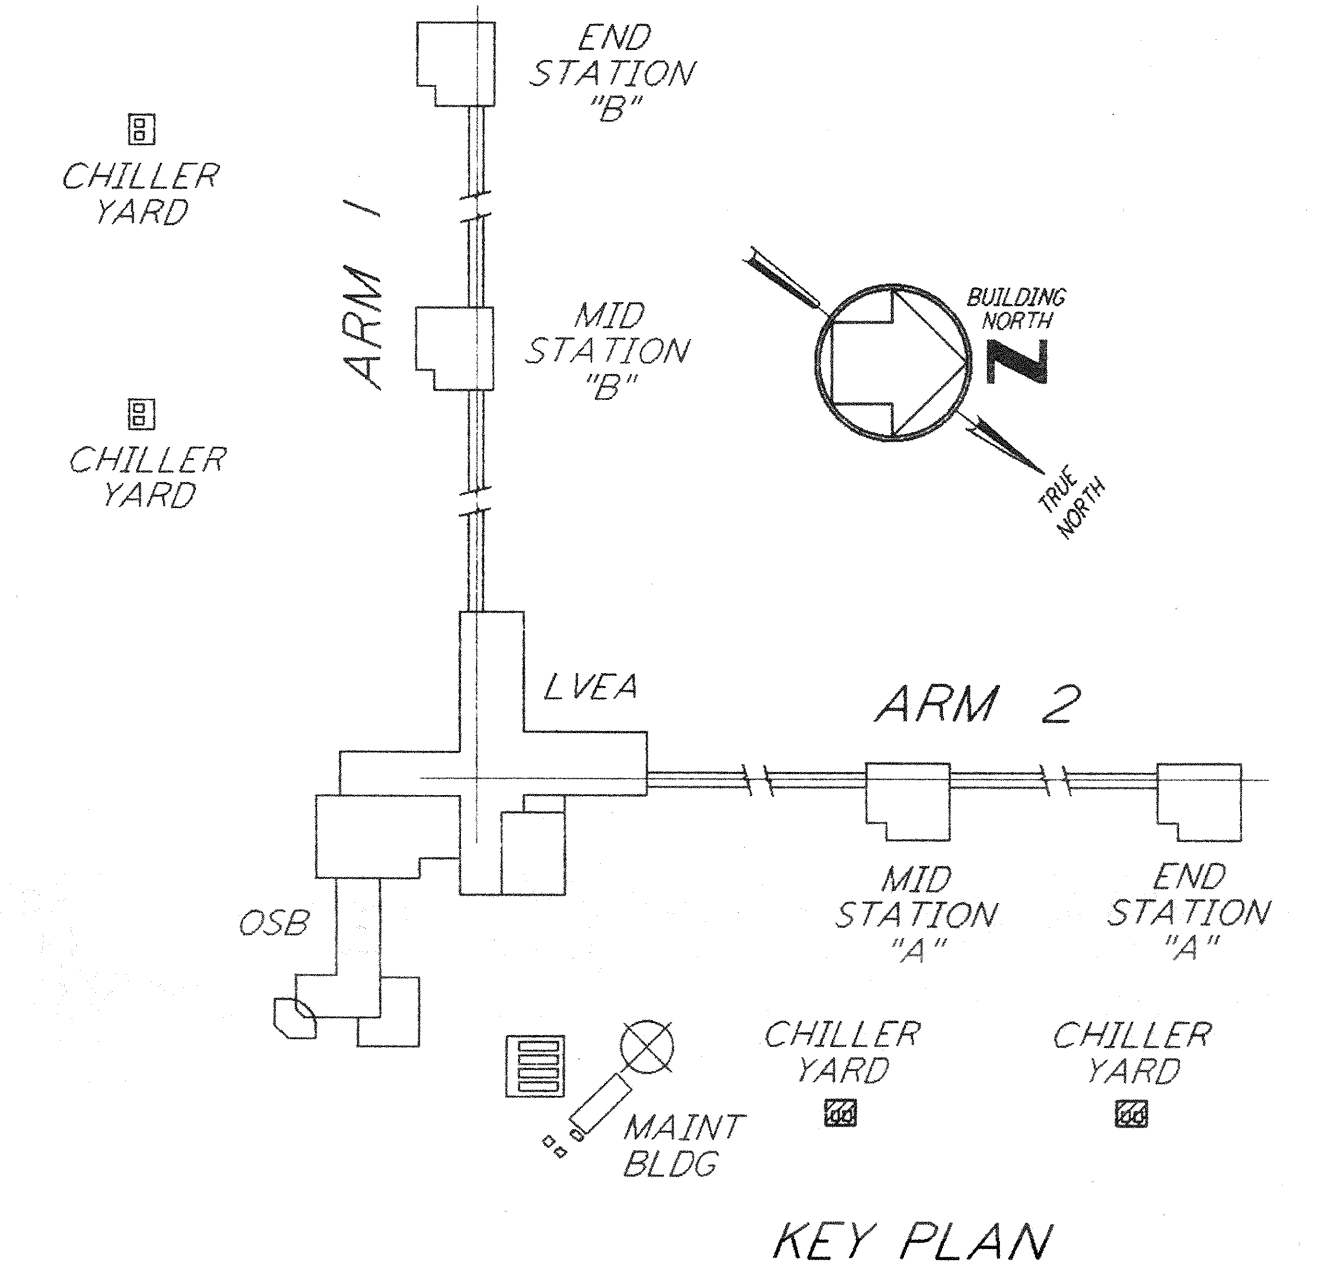


MID AND END STATION "A" CHILLER YARD PLAN

1/4" = 1'-0"

NOTES:

1. FOR LEGEND, ABBREVIATIONS AND GENERAL NOTES SEE SHEET WA-H-001 AND WA-H-002.
2. MAINTAIN 6"-8" CLEAR HEIGHT UNDER PIPES, FOR PIPE SUPPORT DETAILS SEE STRUCTURAL DRAWING WA-5-407.
3. PROVIDE FLOOR MOUNTED ELBOW SUPPORT AT THE PUMP SUCTION. CONTRACTOR MAY USE SUCTION DIFFUSER/STRAINER.
4. REFER TO SPECIFICATIONS FOR PIPE SUPPORT REQUIREMENTS.
5. SUPPORT PIPING TO ELIMINATE ANY LOADS TRANSMITTED FROM PIPING TO PUMPS AND CHILLERS.
6. FOR PIPING FLOW DIAGRAM SEE SHEET WA-H-221.
7. FOR CHILLERS AND PUMPS PIPING DETAILS SEE SHEETS WA-H-411 AND WA-H-412.
8. FOR EXACT LOCATION OF THE CHILLERS AND PUMPS SEE CIVIL DRAWINGS.



KEY PLAN

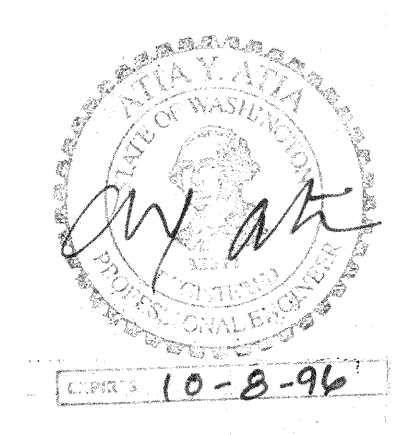
0 4 8 12 16 FT
 1/4" = 1'-0"

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REFERENCES	ISSUED FOR CONSTRUCTION					
	DRAWN	CLP	6-24-96			
REVISIONS	CHECKED	MS	7/2/96			
	ENGINEER	AP	7/3/96			
	PROJ	W. W. W.	7/8/96			
DRAWING NO.	DESCRIPTION					
	NO.	DATE	BY	CHKD	ENGR	PROJ

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LASER INTERFEROMETER GRAVITATIONAL-WAVE OBSERVATORY SITE NO. 1 - HANFORD, WASHINGTON		
TITLE	SCALE	CONTRACT NUMBER
HVAC MID & END STATIONS "A" CHILLER YARD PLAN	AS NOTED	PP150969
	SHEET NUMBER	8094
	WA-H-213	
	LIGO-D960362-00-0	

E
D
C
B
A