



FOR END STATION "A" & MID STATION "A" ON ARM 2 (NORTHWEST ARM)  
**HIGH ROOF FRAMING PLAN**  
 $\frac{1}{8}'' = 1'-0''$

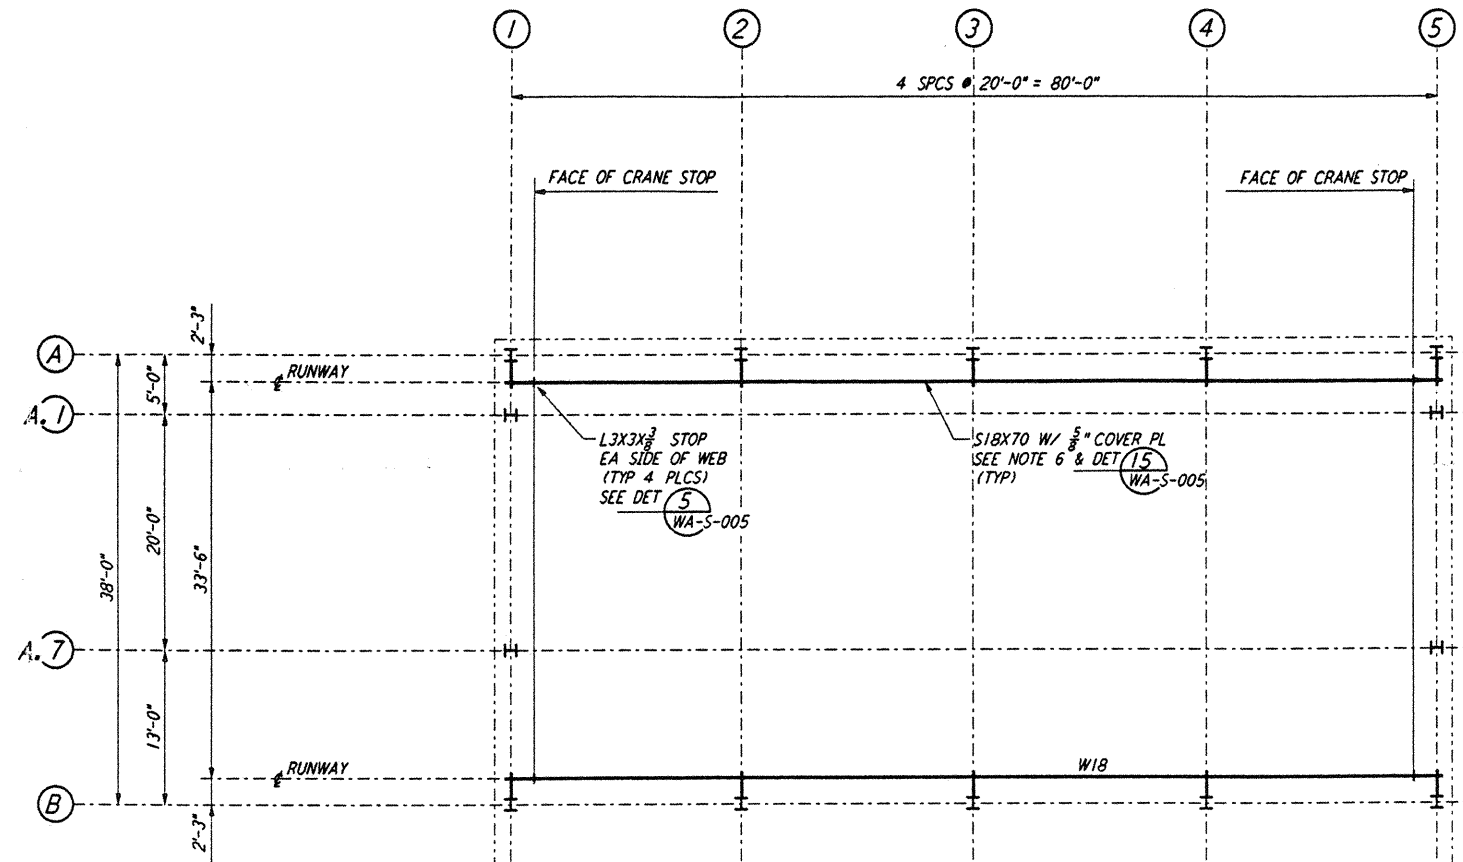



FOR END STATION "A" & MID STATION "A" ON ARM 2 (NORTHWEST ARM)  
**CRANE GIRDER FRAMING PLAN**  
 $\frac{1}{8}'' = 1'-0''$

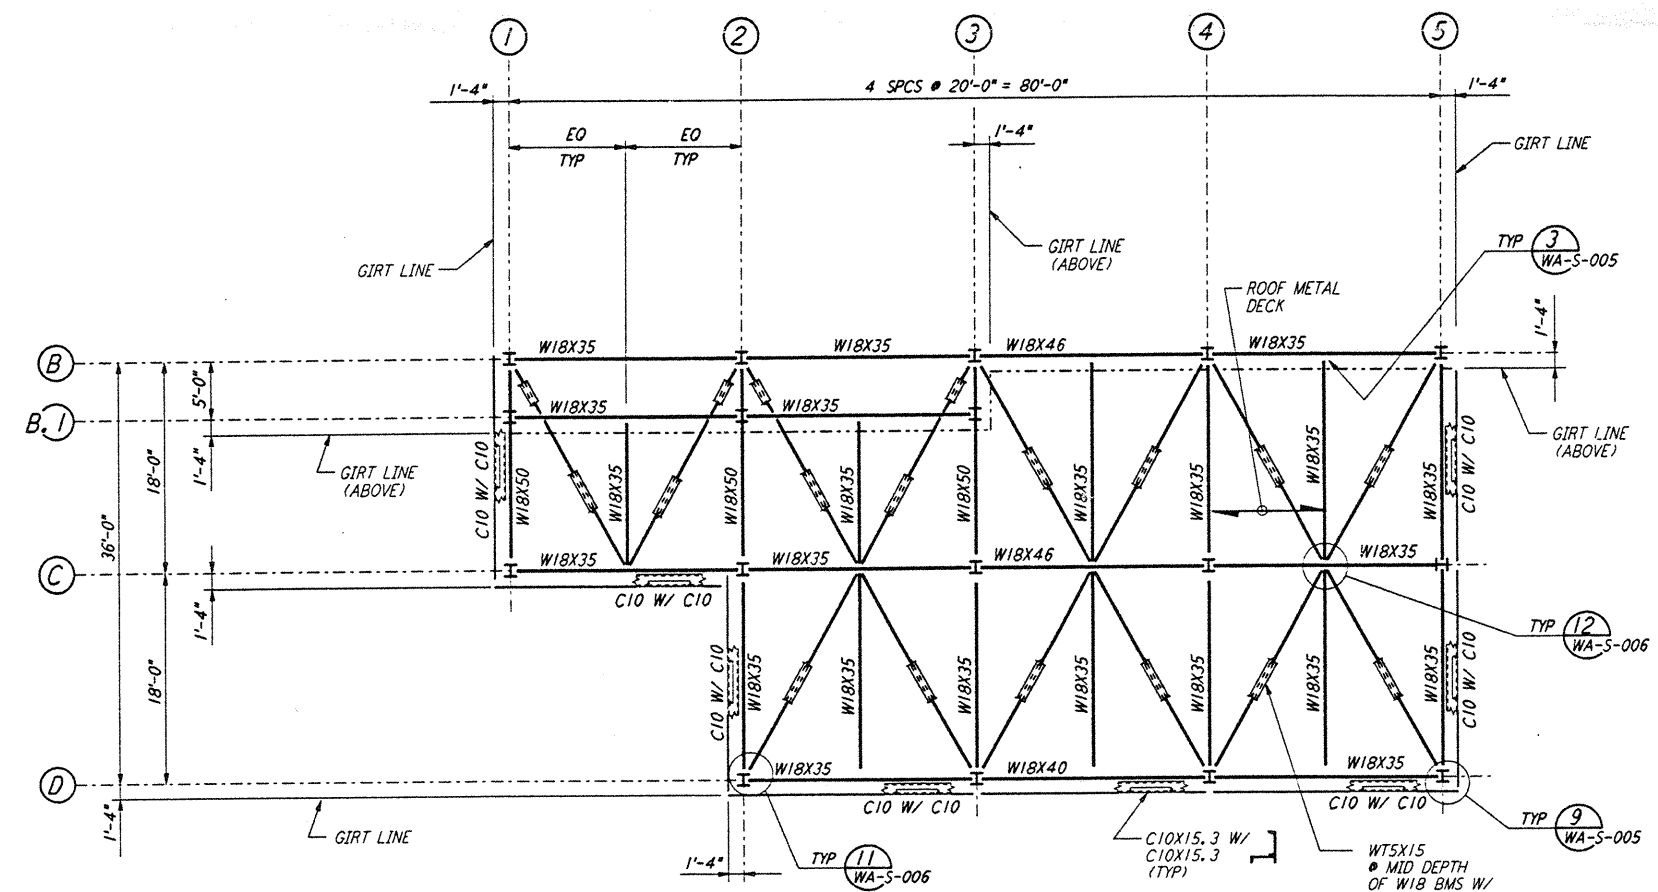

FOR END STATION "A" & MID STATION "A" ON ARM 2 (NORTHWEST ARM)  
**LOW ROOF FRAMING PLAN**  
 $\frac{1}{8}'' = 1'-0''$

**NOTES:**

- FOR GENERAL NOTES, ABBREVIATIONS AND SYMBOLS SEE DRAWING WA-S-001.
- FOR ROOF FRAMING PLANS AND CRANE GIRDER FRAMING PLAN ON THE SOUTHWEST ARM, SEE DRAWING WA-S-209.
- FABRICATOR SHALL STAGGER THE SPLICES IN CRANE RUNWAY GIRDERS.
- FOR ADDITIONAL NOTES SEE DRAWING WA-S-107.
- CRANE STOPS SHALL BE FIELD LOCATED TO PROVIDE CRANE COVERAGE AS PER SPECIFICATIONS.
- ROLLING SURFACE OF CRANE RAILS AND CRANE WHEELS SHALL BE POLISHED TO PROVIDE "FLAKE FREE" OPERATION.

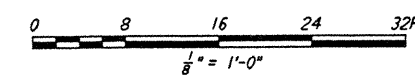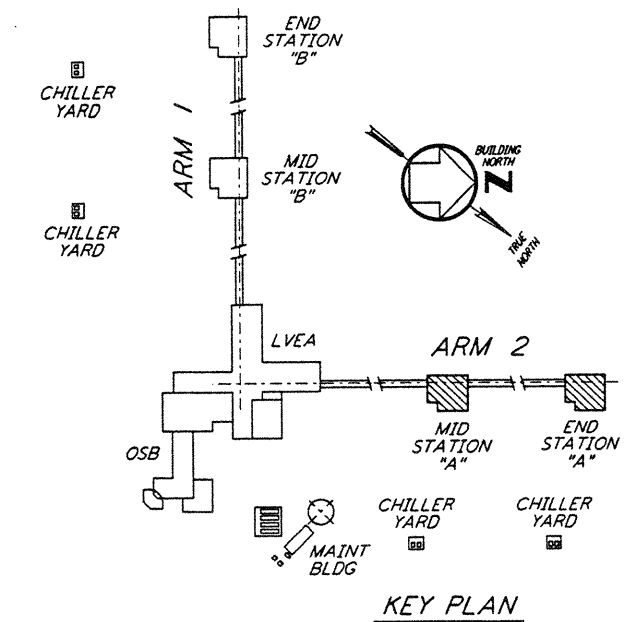


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REFERENCES		REVISIONS		ISSUED FOR CONSTRUCTION	
DRAWING NO.	DESCRIPTION	NO.	DATE	BY	CHKD

DRAWN	MCS	6-24-96
CHECKED	ben	7-2-96
ENGINEER	H	7-28-96
PROJ	WJW	7/9/96



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LASER INTERFEROMETER  
 GRAVITATIONAL-WAVE OBSERVATORY  
 SITE NO. 1 - HANFORD, WASHINGTON

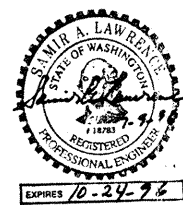TITLE: STRUCTURAL  
 MID & END STATIONS "A"  
 ROOF & CRANE GIRDER  
 FRAMING PLANS

SCALE: AS NOTED  
 CONTRACT NUMBER: PPI50969  
 PROJECT NUMBER: 8094

SHEET NUMBER: **WA-S-204**

LIGO-D960310-00-0

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