


FOR FLOOR SLOPE SEE ARCHITECTURAL DRAWINGS

DATUM POINT EL 100'-0" = EL 531.11'

FOUNDATION PLAN  
 1/8" = 1'-0"

**NOTES:**

1. FOR GENERAL NOTES, ABBREVIATIONS AND SYMBOLS, SEE DRAWING WA-S-001.
2. FOR SLAB ON GRADE DETAILS SEE DRAWING WA-S-002.
3. FOR BASE ANGLE AT EDGE OF SLAB OR TOP OF 6" CONCRETE WALL, SEE FRAMING ELEVATIONS AND SECTION WA-S-003.

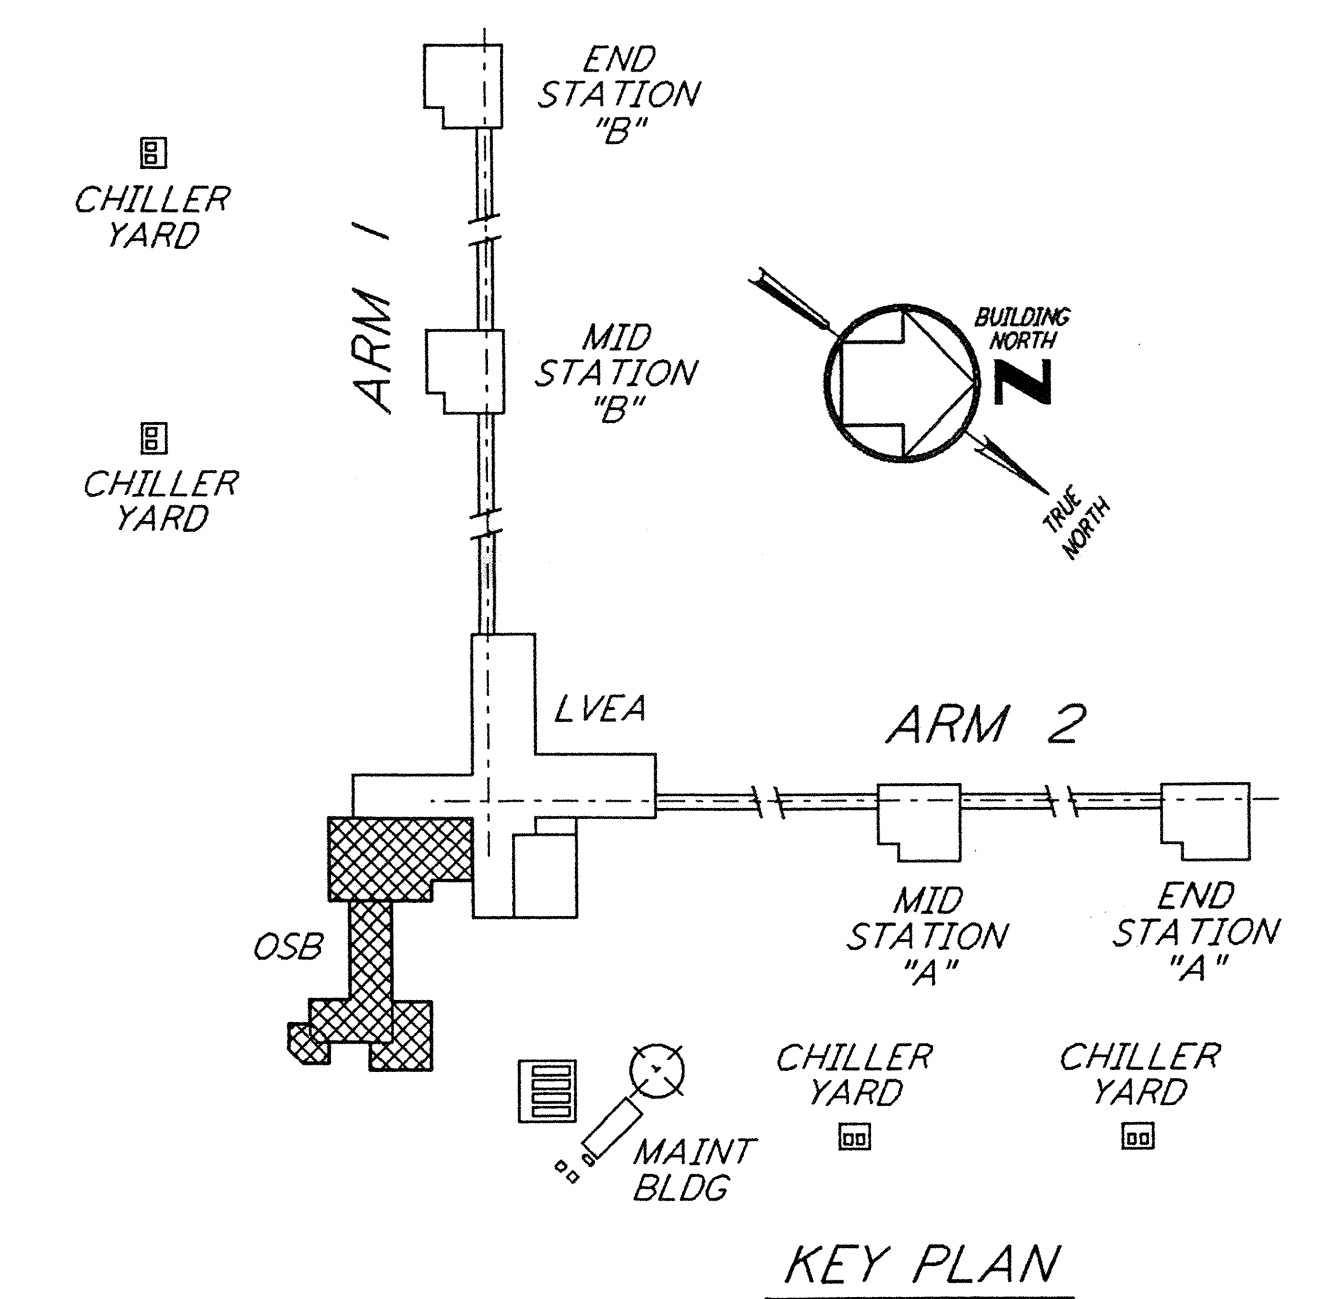

0 8 16 24 32 40 48 56 64 FT  
 1/8" = 1'-0"

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NO.	DATE	BY	CHKD	ENGR	PROJ	DESCRIPTION
C	5-22-96	MCS	BP	TDM	BP	BID ADDENDUM #2
B	4-19-96	MCS	DDM	TDM	BP	FINAL DESIGN REVIEW & BID
A	10-31-95			TDM		PRELIMINARY DESIGN REVIEW

DRAWN	MCS
CHECKED	
ENGINEER	
PROJ	

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LASER INTERFEROMETER  
 GRAVITATIONAL-WAVE OBSERVATORY  
 SITE NO. 1 - HANFORD, WASHINGTON

TITLE	STRUCTURAL CORNER STATION OSB FOUNDATION PLAN
SCALE	AS NOTED
CONTRACT NUMBER	PP150969
PROJECT NUMBER	8094
SHEET NUMBER	<b>WA-S-102</b>
REVISIONS	

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