



MID/END STATIONS ROOF PLAN  
 1/8" = 1'-0" WA-A-221

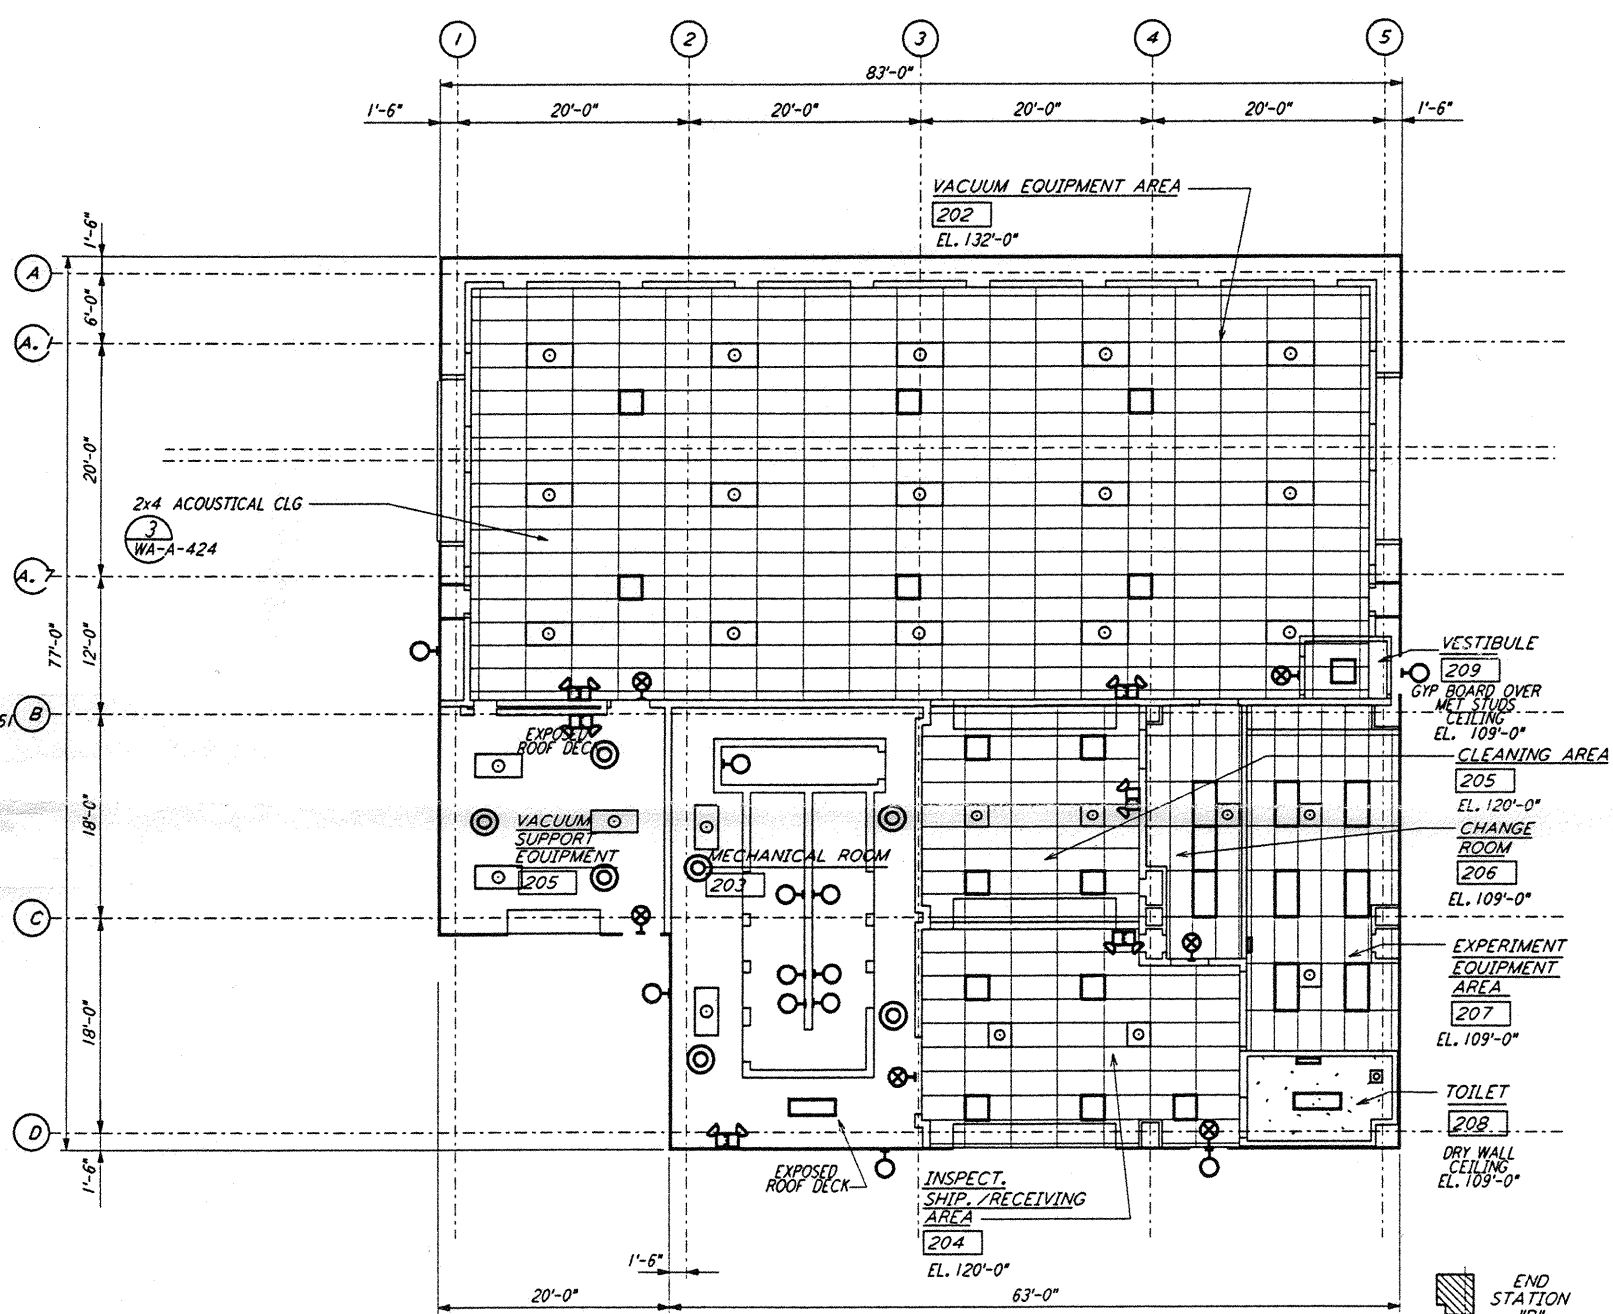

MID/END STATIONS REFLECTED CEILING PLAN  
 1/8" = 1'-0" WA-A-221

0 8 16 24 32 FT  
 1/8" = 1'-0"

DATUM POINT EL +100.00 = 531.11' ( LVEA )  
 DATUM POINT EL +100.00 = 531.11' ( OSB )  
 DATUM POINT EL +100.00 = 528.07' ( MID NORTH )  
 DATUM POINT EL +100.00 = 527.05' ( END NORTH )  
 DATUM POINT EL +100.00 = 532.22' ( MID SOUTH WEST )  
 DATUM POINT EL +100.00 = 535.26' ( END SOUTH WEST )

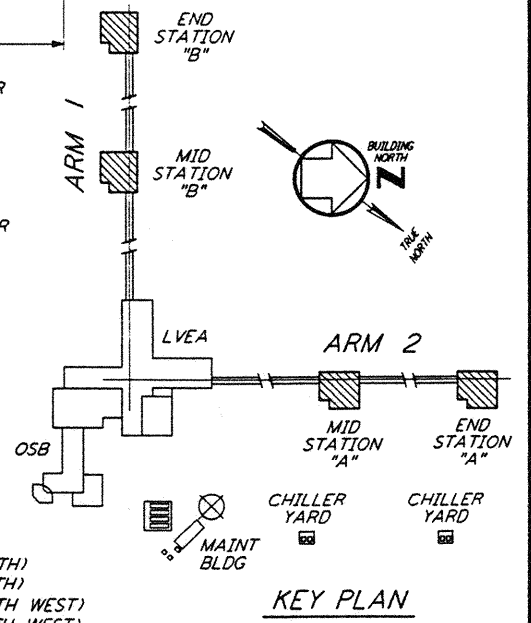

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DRAWING NO.	DESCRIPTION	NO.	DATE	BY	CHKD	ENGR	PROJ	DESCRIPTION

ISSUED FOR CONSTRUCTION			
DRAWN	CRT	5-12-96	
CHECKED	TB	5-26-96	
ENGINEER	TKS	7-12-96	
PROJ	HUN	7-12-96	

*Handwritten signature and date: 10/1/96*

**PARSONS**  
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 GRAVITATIONAL-WAVE OBSERVATORY  
 SITE NO. 1 - HANFORD, WASHINGTON

ARCHITECTURAL  
 MID & END STATIONS  
 REFLECTED CEILING PLAN  
 & ROOF PLAN

AS NOTED PPI50969 8094  
**WA-A-221**