
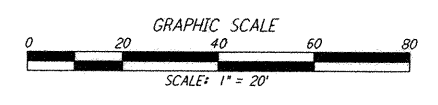
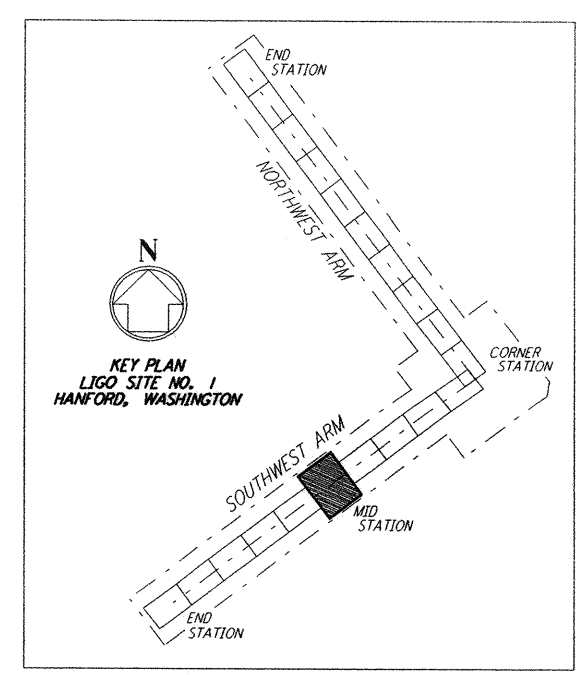
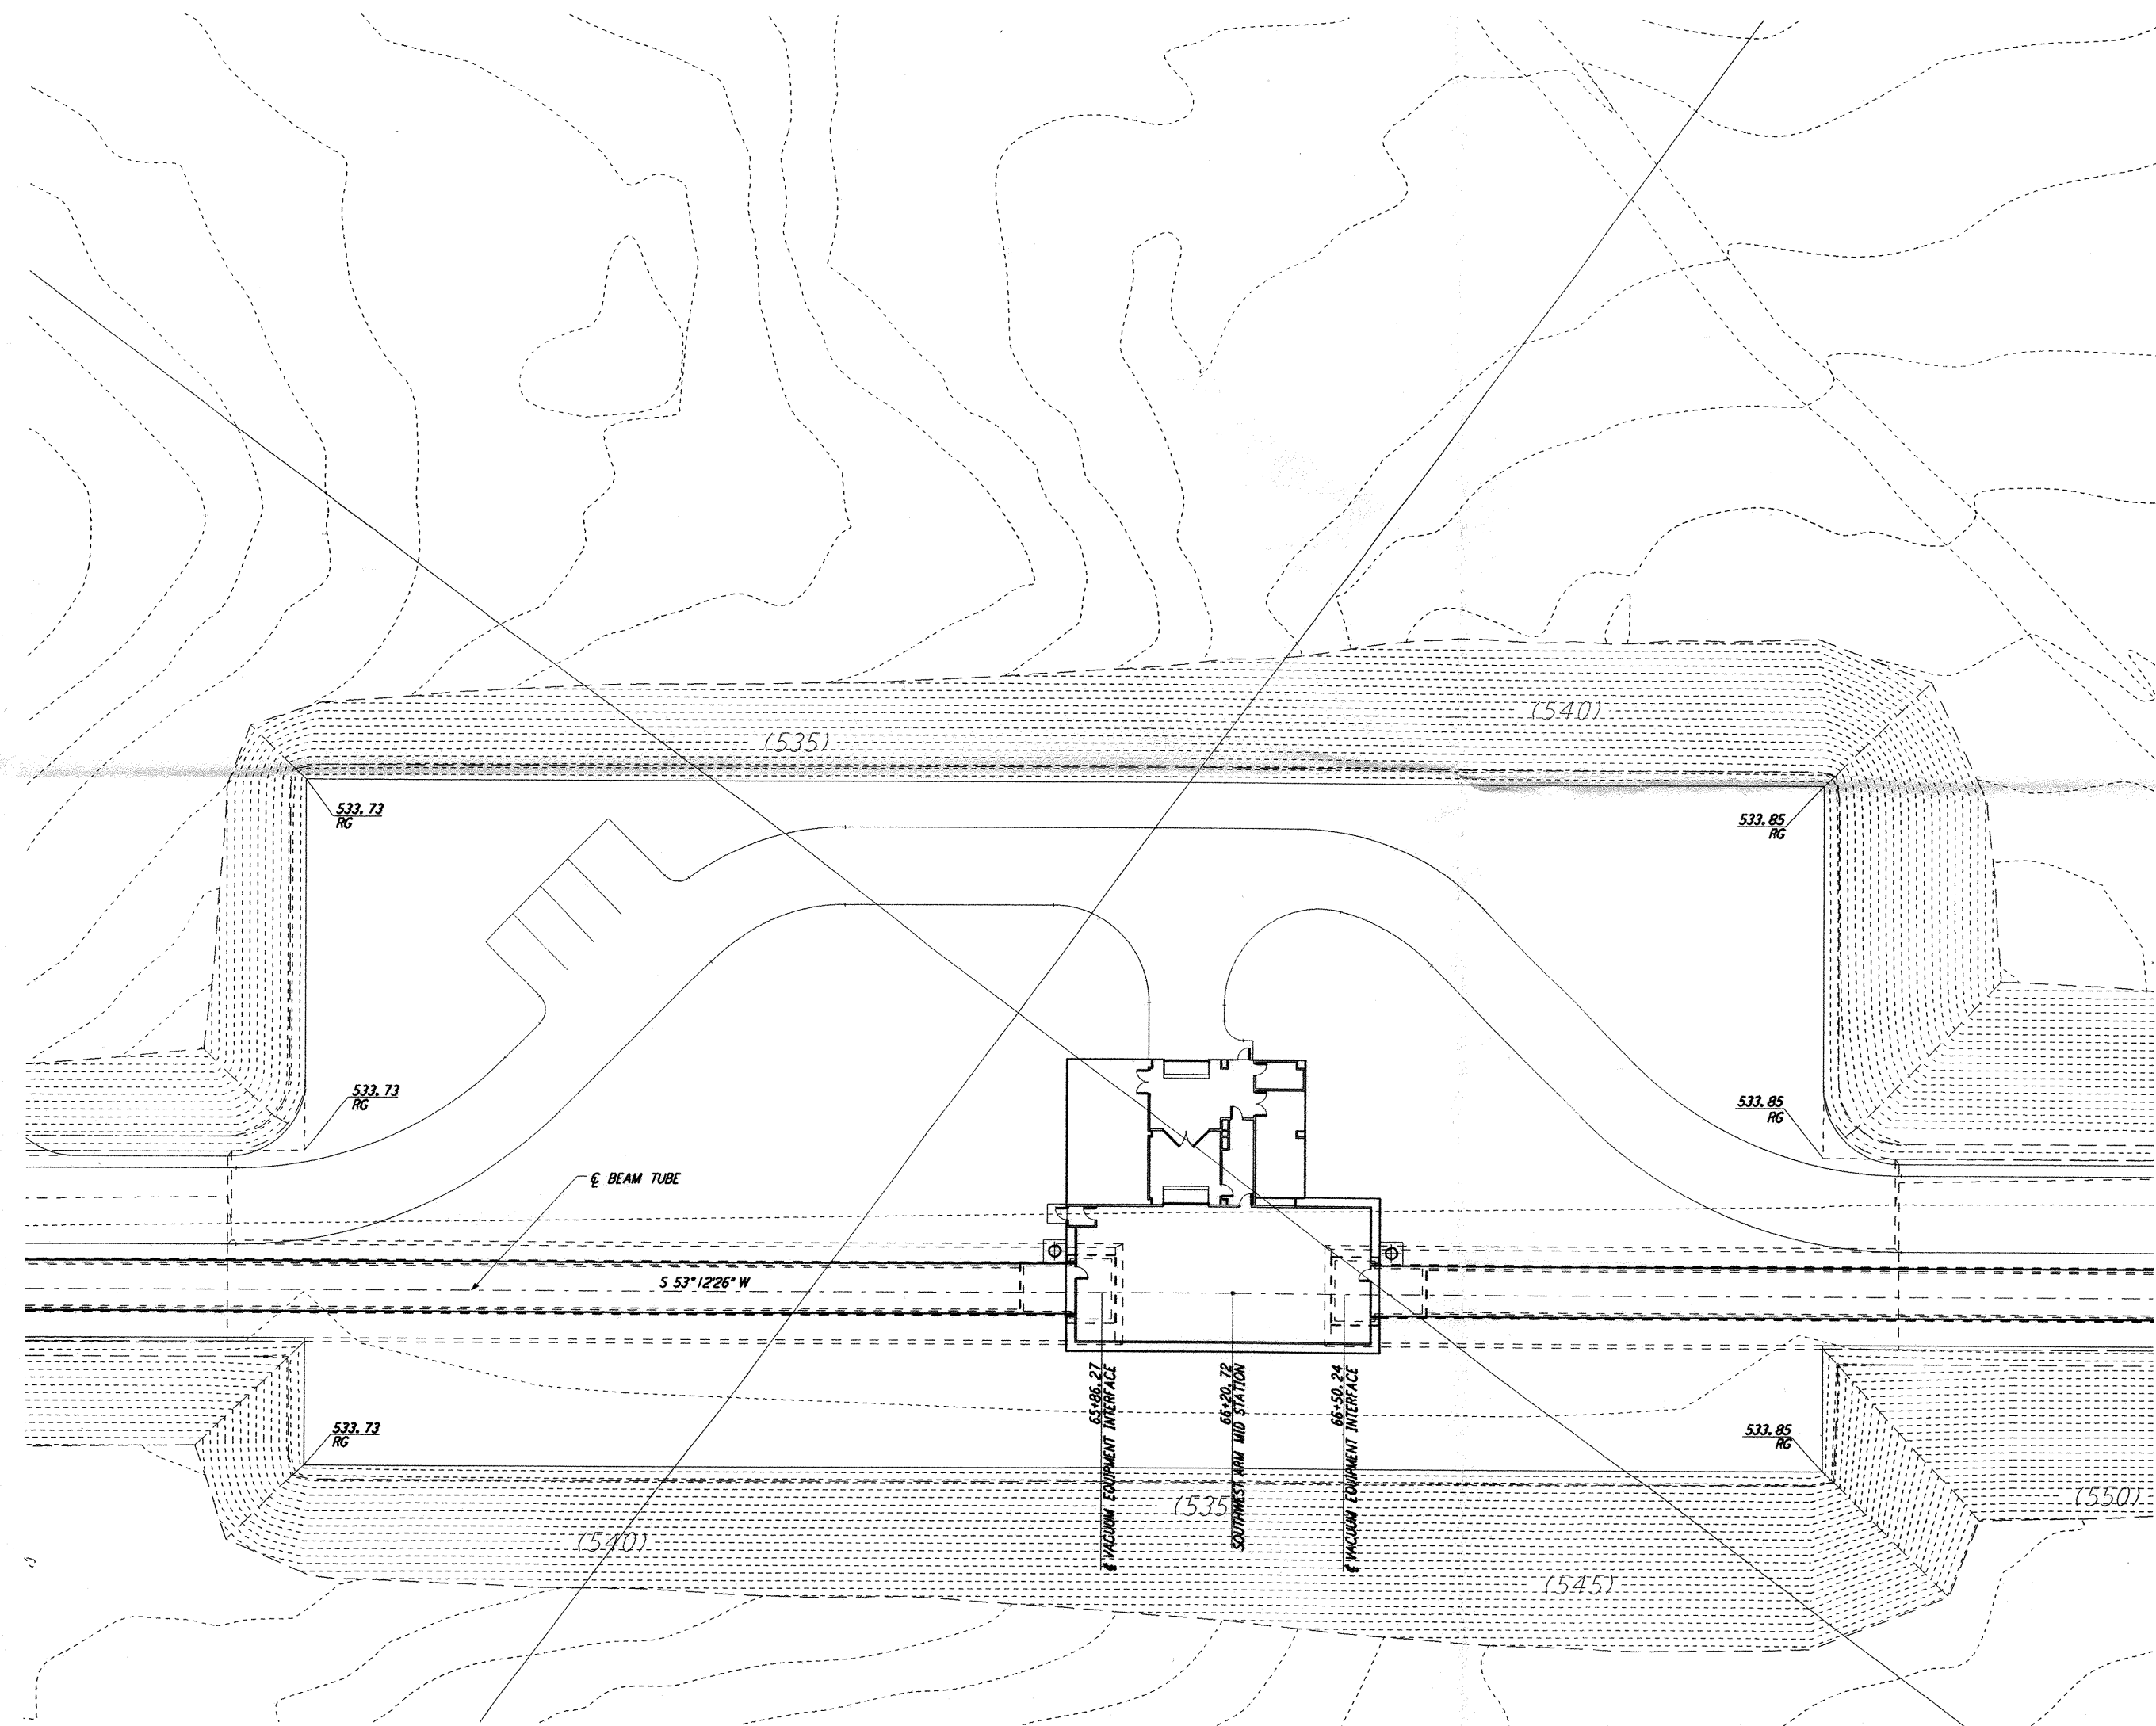


NOTES:
 1. SEE SHEET WA-C-002 FOR GENERAL NOTES, LEGEND AND ABBREVIATIONS.

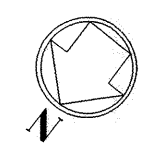

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NO.	DATE	APRD BY	DESCRIPTION OF REVISION
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NO.	DATE	APRD BY	ISSUED FOR
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1	10/31/95	TDM	PRELIMINARY DESIGN REVIEW

DATE	DRAWN	CHECKED	ENGINEER	PROJ. MGR	CLIENT
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LASER INTERFEROMETER
 GRAVITATIONAL-WAVE OBSERVATORY
 SITE NO. 1 - HANFORD, WASHINGTON

TITLE: SOUTHWEST ARM
 MID-STATION, PLOT,
 GRADING & UTILITY PLANS

SCALE: 1" = 20'

CONTRACT NUMBER: PPI50969
 PROJECT NUMBER: 8094

SHEET NUMBER: **WA-C-041**

Tue Oct 31 08:30:45 1995 s3-v18b2 J:\PLOTS\QUEUES\18B2\CE041.PR