
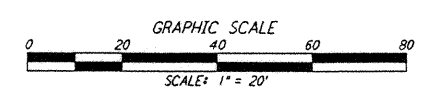
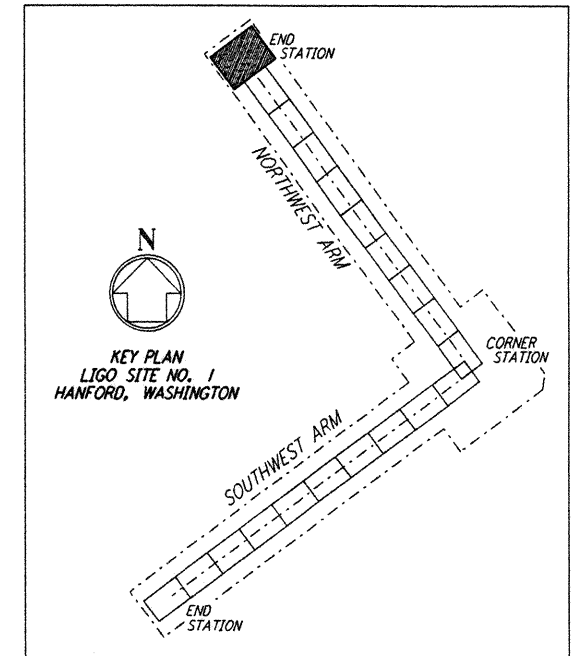
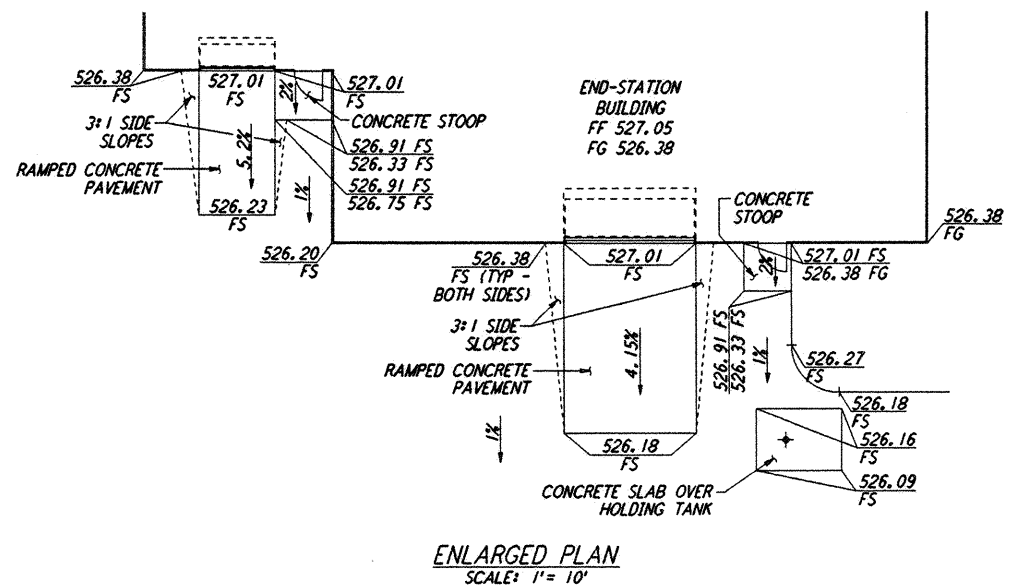


NOTES:
 1. SEE SHEET WA-C-002 FOR GENERAL NOTES, LEGEND AND ABBREVIATIONS.

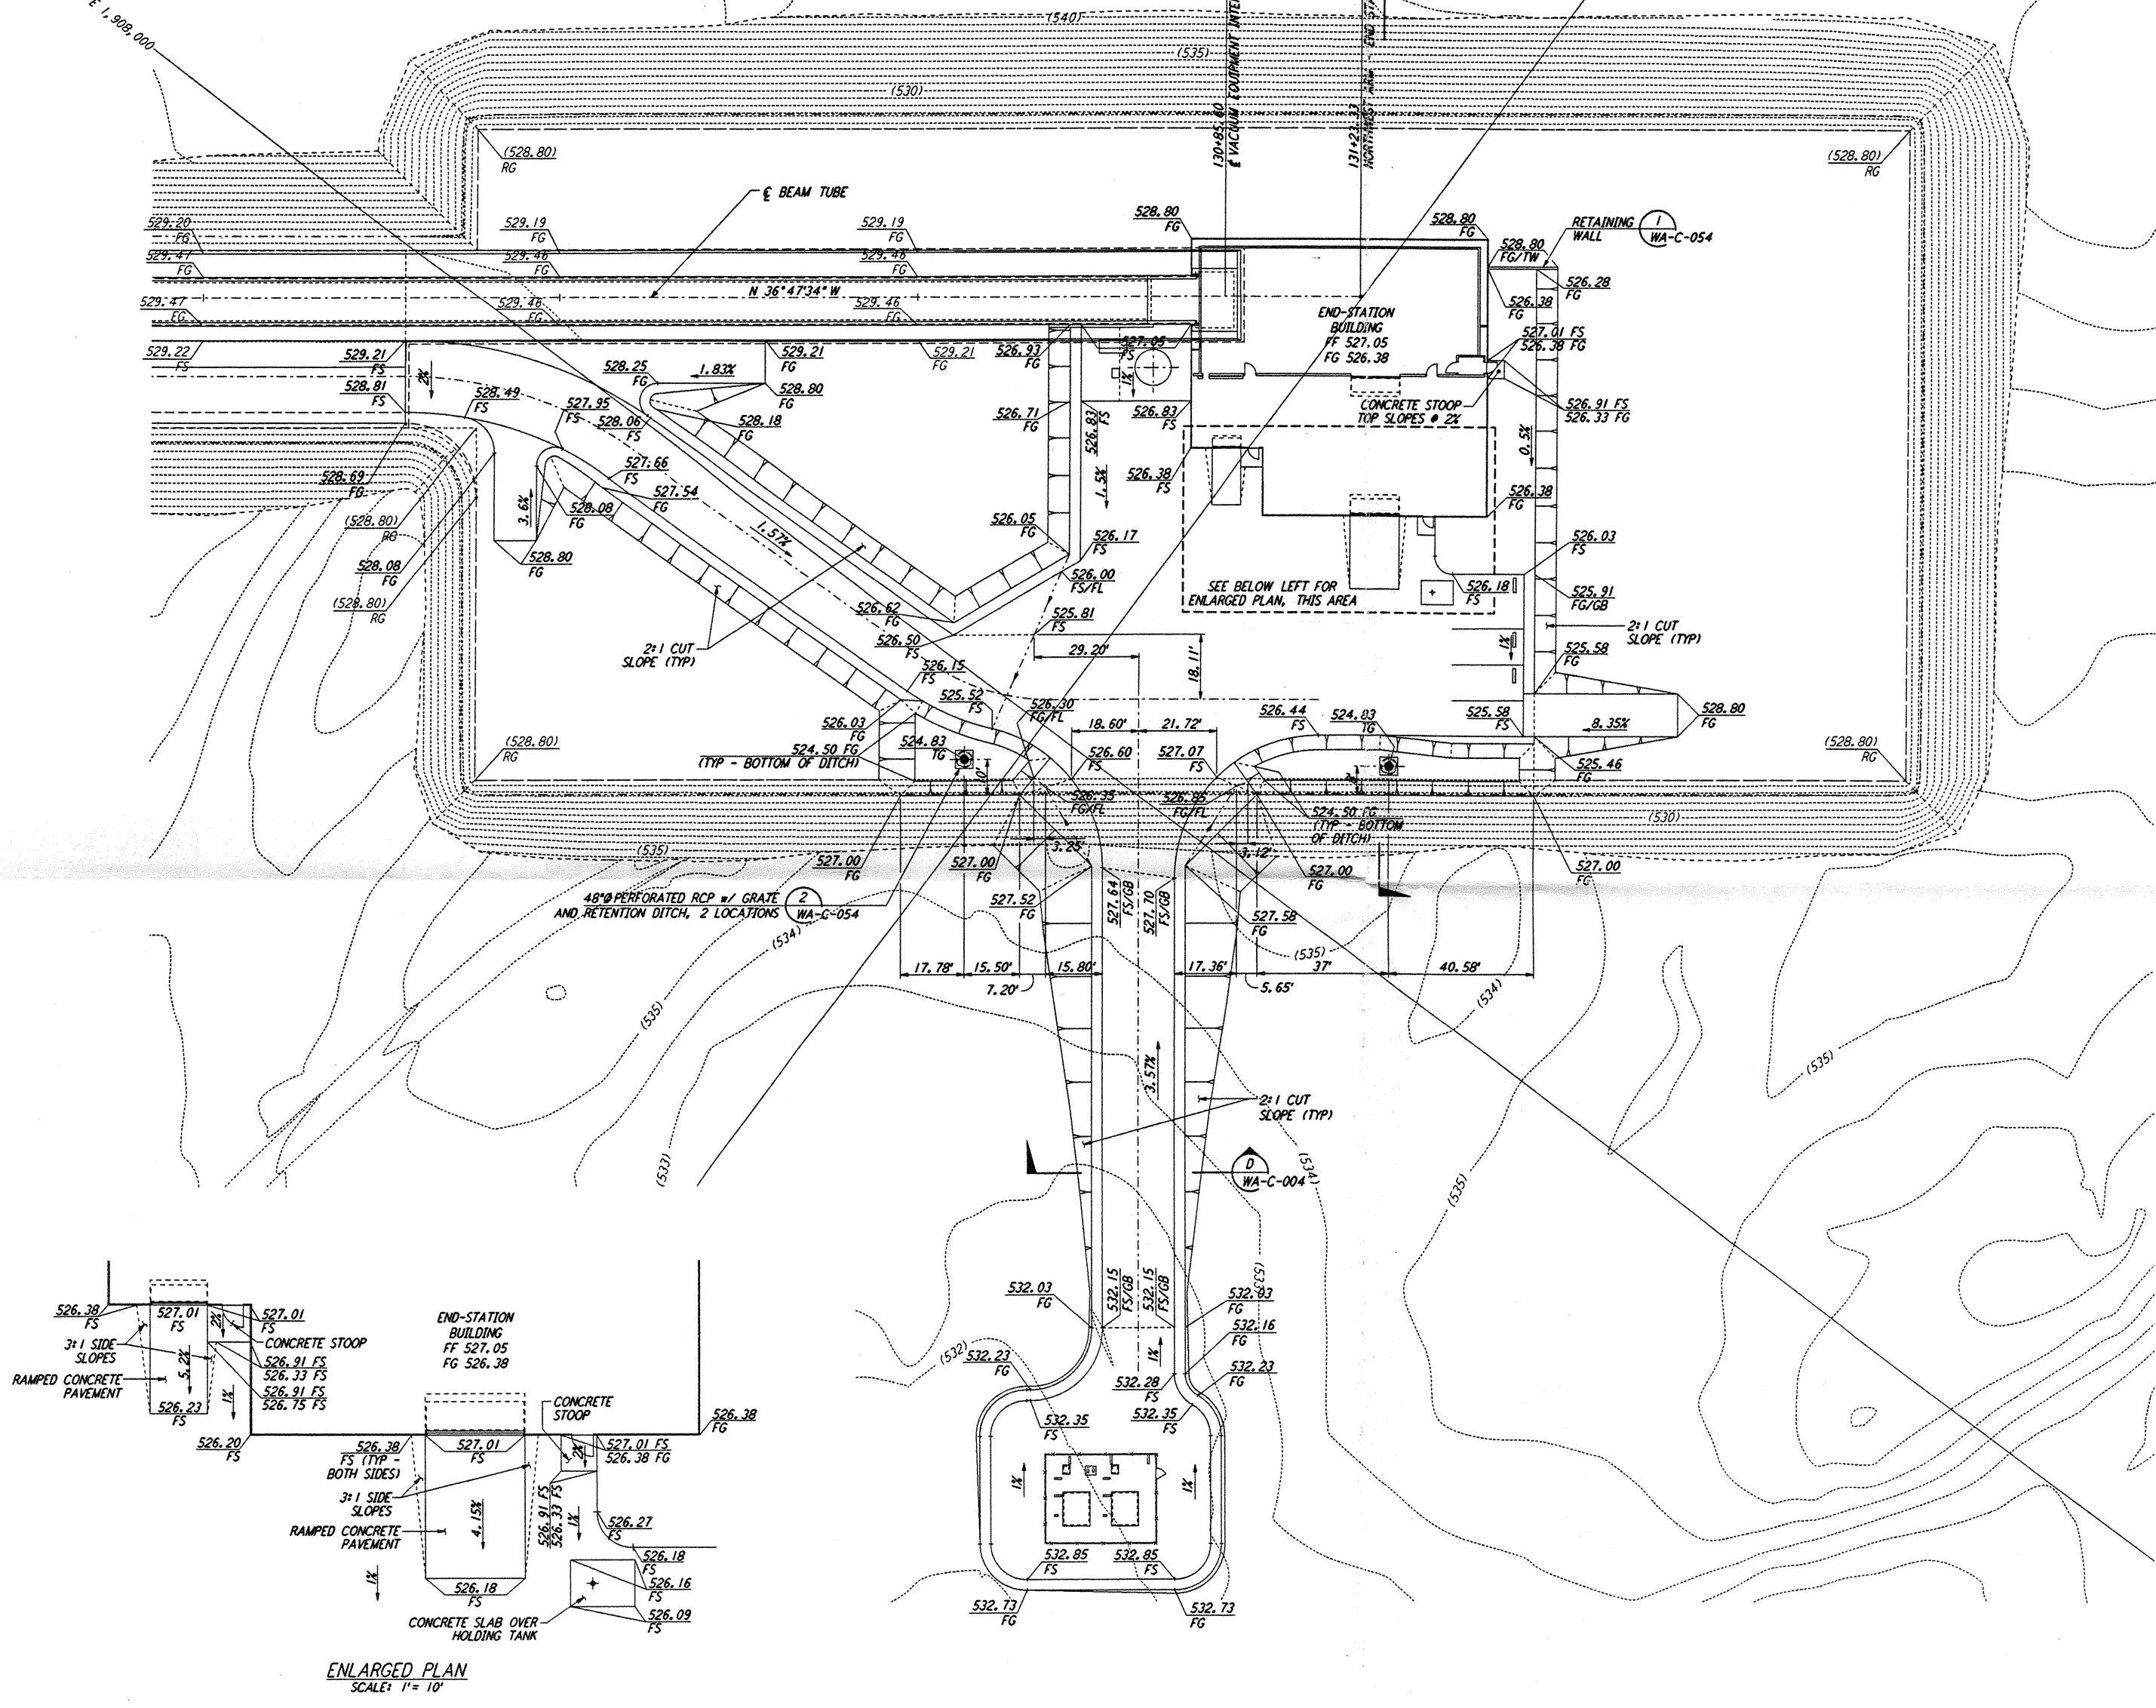

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NO.	DATE	BY	CHKD	ENGR	PROJ	DESCRIPTION
B	5/22/96	WRB				BID ADDENDUM #2
A	4/19/96	WRB	ML	JB	MHW	FINAL DESIGN REVIEW & BID

DRAWN	WRB
CHECKED	
ENGINEER	
PROJ	

PARSONS
 100 WEST WALNUT STREET
 PASADENA, CALIFORNIA

LIGO
 CALIFORNIA INSTITUTE OF TECHNOLOGY
 MASSACHUSETTS INSTITUTE OF TECHNOLOGY

**LASER INTERFEROMETER
 GRAVITATIONAL-WAVE OBSERVATORY
 SITE NO. 1 - HANFORD, WASHINGTON**

CIVIL NORTHWEST ARM END-STATION GRADING PLAN

SCALE 1" = 20'

CONTRACT NUMBER PPI50969 PROJECT NUMBER 8094

SHEET NUMBER **WA-C-026** REVISIONS

LIGO-D960216-B-0

LIGOVAF3.BDR